# DUVAL COUNTY COURTHOUSE Roof Remediation, Exterior Windows, & Electrical San Diego, Texas

### OWNER

Judge Arnoldo Cantu Duval County 400 E. Gravis Ave. San Diego, Texas 78384 Email: arnoldo.cantu@co.duval.tx.us Phone: 361.279.6204

### ARCHITECT

ARCHITEXAS Architecture, Planning, and Historic Preservation, Inc. 1023 Springdale Rd., Bldg. 11, Suite E Austin, TX 78704 Email: sfrocheur@architexas.com Phone: 512.444.4220 Fax: 512.444.4221


### MEP ENGINEER

Brown Consulting Engineers Inc. 3505 Olsen Blvd., Suite 110 Amarillo, TX 79109 Email: james.hartman@brownconsultingengineers.com Phone: 806.354.0141

### **TEXAS HISTORICAL COMMISSION**

Tania Salgado, Courthouse Reviewer 108 W. 16th St. - Second Floor Austin, TX 78701 Email: tania.salgado@thc.texas.gov Phone: 512.462.6088

### AREA MAP

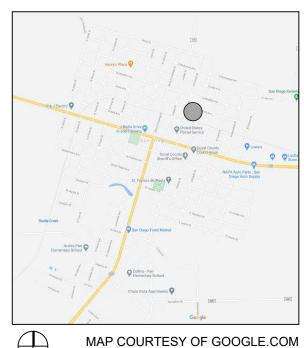

### LOCATOR MAP





### GENERAL NOTES

### 1. Existing Conditions:

- A. Information contained on these drawings with regard to existing conditions for construction in no way releases the Contractor from the responsibility for verifying completely all field conditions relating to and affecting the execution of the work, as described in these Contract Documents. Cease work, notify Architect, and await instructions if materials or conditions encountered at the site are not as indicated by the Contract Documents.
- Field verification of existing conditions relating to specific portions of the work shall be 6. Photographs: В. undertaken in advance to allow for the timely identification of existing conditions that may effect the scheduled installation of new work as designed and detailed, and to avoid undue and unreasonable delays to the project should such conditions be discovered. Timely identifications of such conditions shall provide for a reasonable period of time during which the Architect will evaluate the conditions and make recommendations for accommodating new work.
- Assist the Architect in making their evaluations and recommendations by providing in a 7. Exterior: C. timely manner, at no additional cost to the Owner, accurate and complete drawings, sketches, and photographs sufficient to clearly describe discrepancies, conflicts, and concealed or otherwise unanticipated existing conditions affecting new construction. Assist the Architect by providing in a timely manner prepared solutions to unanticipated existing conditions.
- The Architect has endeavored to identify as completely as possible in the drawings and D. specifications existing items that are required to be removed or otherwise demolished so as to allow the execution of new work. This information is provided for the convenience of the Contractor, and is in no way intended to mean that demolition is limited only to those items specifically identified. Execute demolition work as required to allow the execution of new work
- E. Areas and items indicating limits of work and lines of demarcation are shown for the convenience of the Contractor, and are not to be taken literally. Actual contract limits are to be determined prior to bid openings by field verification.
- F. Original elements removed are to be re-installed in their original location, unless noted

### otherwise.

- 2. Blocking and Framing
  - Some general assumptions have been made on existing blocking, framing, and existing masonry profiles where conditions have not been uncovered. Re-secure existing blocking as necessary and provide new blocking as needed at door frames, door casings, windows, window casing, baseboards, chair rail, and other millwork areas.
- 3. Dimension of original materials:
  - Dimensions indicated in Construction Documents for original materials are approximate and are to be field verified prior to submittal of shop drawings. Match exact sizes and profiles of original elements, unless noted otherwise.

### 4. Sealants

- Remove existing sealants and replace with specified sealants, typical. Masonry infill:
- Masonry infill is to match adjacent material type, size, coursing, color, mortar, etc.

Photographs of existing building conditions are included on portions of these drawings. Information contained on these photographs is provided for the convenience of the Contractor. Existing conditions may vary from what these photographs show. It shall be the responsibility of the Contractor to verify field conditions prior to the time of the bid and alert the Architect to any discrepancies between the existing conditions and the photographs.

- Existing construction shown to remain shall not be damaged during the demolition process. Provide temporary protection as necessary. If surfaces of wall are damaged, damaged areas shall be repaired with masonry to match existing and restore the full structural capacity of the walls.
- Shoring drawings and associated structural calculations sealed by a Professional Engineer licensed in the State of Texas shall be submitted to the Architect's file and shall not be returned approved to the Contractor. The Contractor is solely responsible for the design and installation of all shoring necessary to accomplish the work.
- All shoring shall transfer loading directly to existing masonry structure. Shoring shall be designed to support the full anticipated loading with no benefit from the existing structural framing.
- The maximum allowable loading on the existing floor structures shall be 100 psf. All areas of the building which may have greater loading imposed on it by the Contractor's demolition procedure shall be shored.

SYMBOLS LEGEND Column Center Lines \_\_\_\_ بى Center Line (104A) Door Type (1.20) Window Type 1A — Wall Type ROOM NAME 222 MATERIALS LEGEND Earth/Compact Fi Gravel Fill Concrete Hollow Clay Tile Masonry Split Face CMU Glass Aluminum Steel \_\_\_\_\_ Sheet Metal Existing, Where Noted

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### INDEX OF DRAWINGS

COVER SHEET

- ARCHITECTURAL SITE PLAN SITE DETAILS BASEMENT FLOOR PLAN FIRST FLOOR PLAN SECOND FLOOR PLAN ATTIC PLAN ROOF PLAN NORTH & SOUTH EXTERIOR ELEVATIONS EAST & WEST EXTERIOR ELEVATIONS ROOF DETAILS DOOR SCHEDULE, TYPES, NOTES, & DETAILS WINDOW SCHEDULE, TYPES, & NOTES WINDOW DETAILS FINISH SCHEDULE, WALL TYPES, & CEILING DETAILS ENLARGED DEMO PLAN, FLOOR PLAN, & REFLECTED CEILING PLAN INTERIOR ELEVATIONS ADA DIAGRAMS
  - MECHANICAL & PLUMBING COVER SHEET & SPECIFICATIONS **MECHANICAL & PLUMBING SPECIFICATIONS**

BASEMENT ENLARGED MECHANICAL FLOOR PLANS

BASEMENT ENLARGED PLUMBING DEMOLITION PLANS BASEMENT ENLARGED PLUMBING PLANS

ELECTRICAL COVER SHEET ELECTRICAL SITE PLAN BASEMENT ELECTRICAL FLOOR PLAN FIRST FLOOR ELECTRICAL FLOOR PLAN SECOND FLOOR ELECTRICAL FLOOR PLAN THIRD FLOOR ELECTRICAL FLOOR PLAN ATTIC ELECTRICAL FLOOR PLAN ROOF ELECTRICAL FLOOR PLAN ENLARGED BASEMENT ELECTRICAL FLOOR PLANS ELECTRICAL DETAILS PANEL SCHEDULES

# 

ABBREVIATIONS

Broken Section

Wall Sectior

Detail Sectior

Detail Kev

Detail Key

Elevation Key

KX/AX.UU

X/A X 00

X/A X OC

±	PLUS/MINUS
Ø	DIAMETER
A/C	AIR CONDITIONER
ACM	ASBESTOS CONTAINING
	MATERIAL
AHU	AIR HANDLING UNIT
CABS.	CABINETS
CLG.	CEILING
CONC.	CONCRETE
DN.	DOWN
ELEV.	ELEVATOR
EQ.	EQUAL
EQUIP.	EQUIPMENT
EXIST.	EXISTING
FIXT.	FIXTURES
FLR.	FLOOR
F.R.	FIRE RATED
GYP.	GYPSUM
HIST.	HISTORIC
MECH.	MECHANICAL
MISC.	MISCELLANEOUS
MTL.	METAL
OC	ON CENTER
ORIG.	ORIGINAL
QTR.	QUARTER
REF.	REFERENCE
REQ'D	REQUIRED
STRUCT.	STRUCTURAL
T.B.D.	TO BE DETERMINED
TYP.	TYPICAL
U.O.N	UNLESS OTHERWISE NOTE
VIF	VERIFY IN FIELD
W/	WITH
WD.	WOOD
WITH ARC	NTRACTOR SHALL VERIFY HITECT FOR ANY TION NOT LISTED.



ROOF REMEDIATION, EXTERIOR WINDOWS, & ELECTRICAL

> 400 E. Gravis Ave. San Diego, Texas 78384

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1. Issued for Bid June 19, 2025

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Architexas No. 2433 Sheet Name

Date 6/19/2025

COVER SHEET


**Sheet Number** 



# Room Name and Number XX/A0.00 Rough Wood >Blocking Finish Wood tion

	Plywood
	Rigid Insulation
	Thermal Batt Insulati
	Acoustic Batt Insulati
	Sprayed Insulation
$\frown$	Sprayed Fire Insulati
	Ceramic Tile
	Gypsum Board

XXXXXX Metal Lath and Plaster

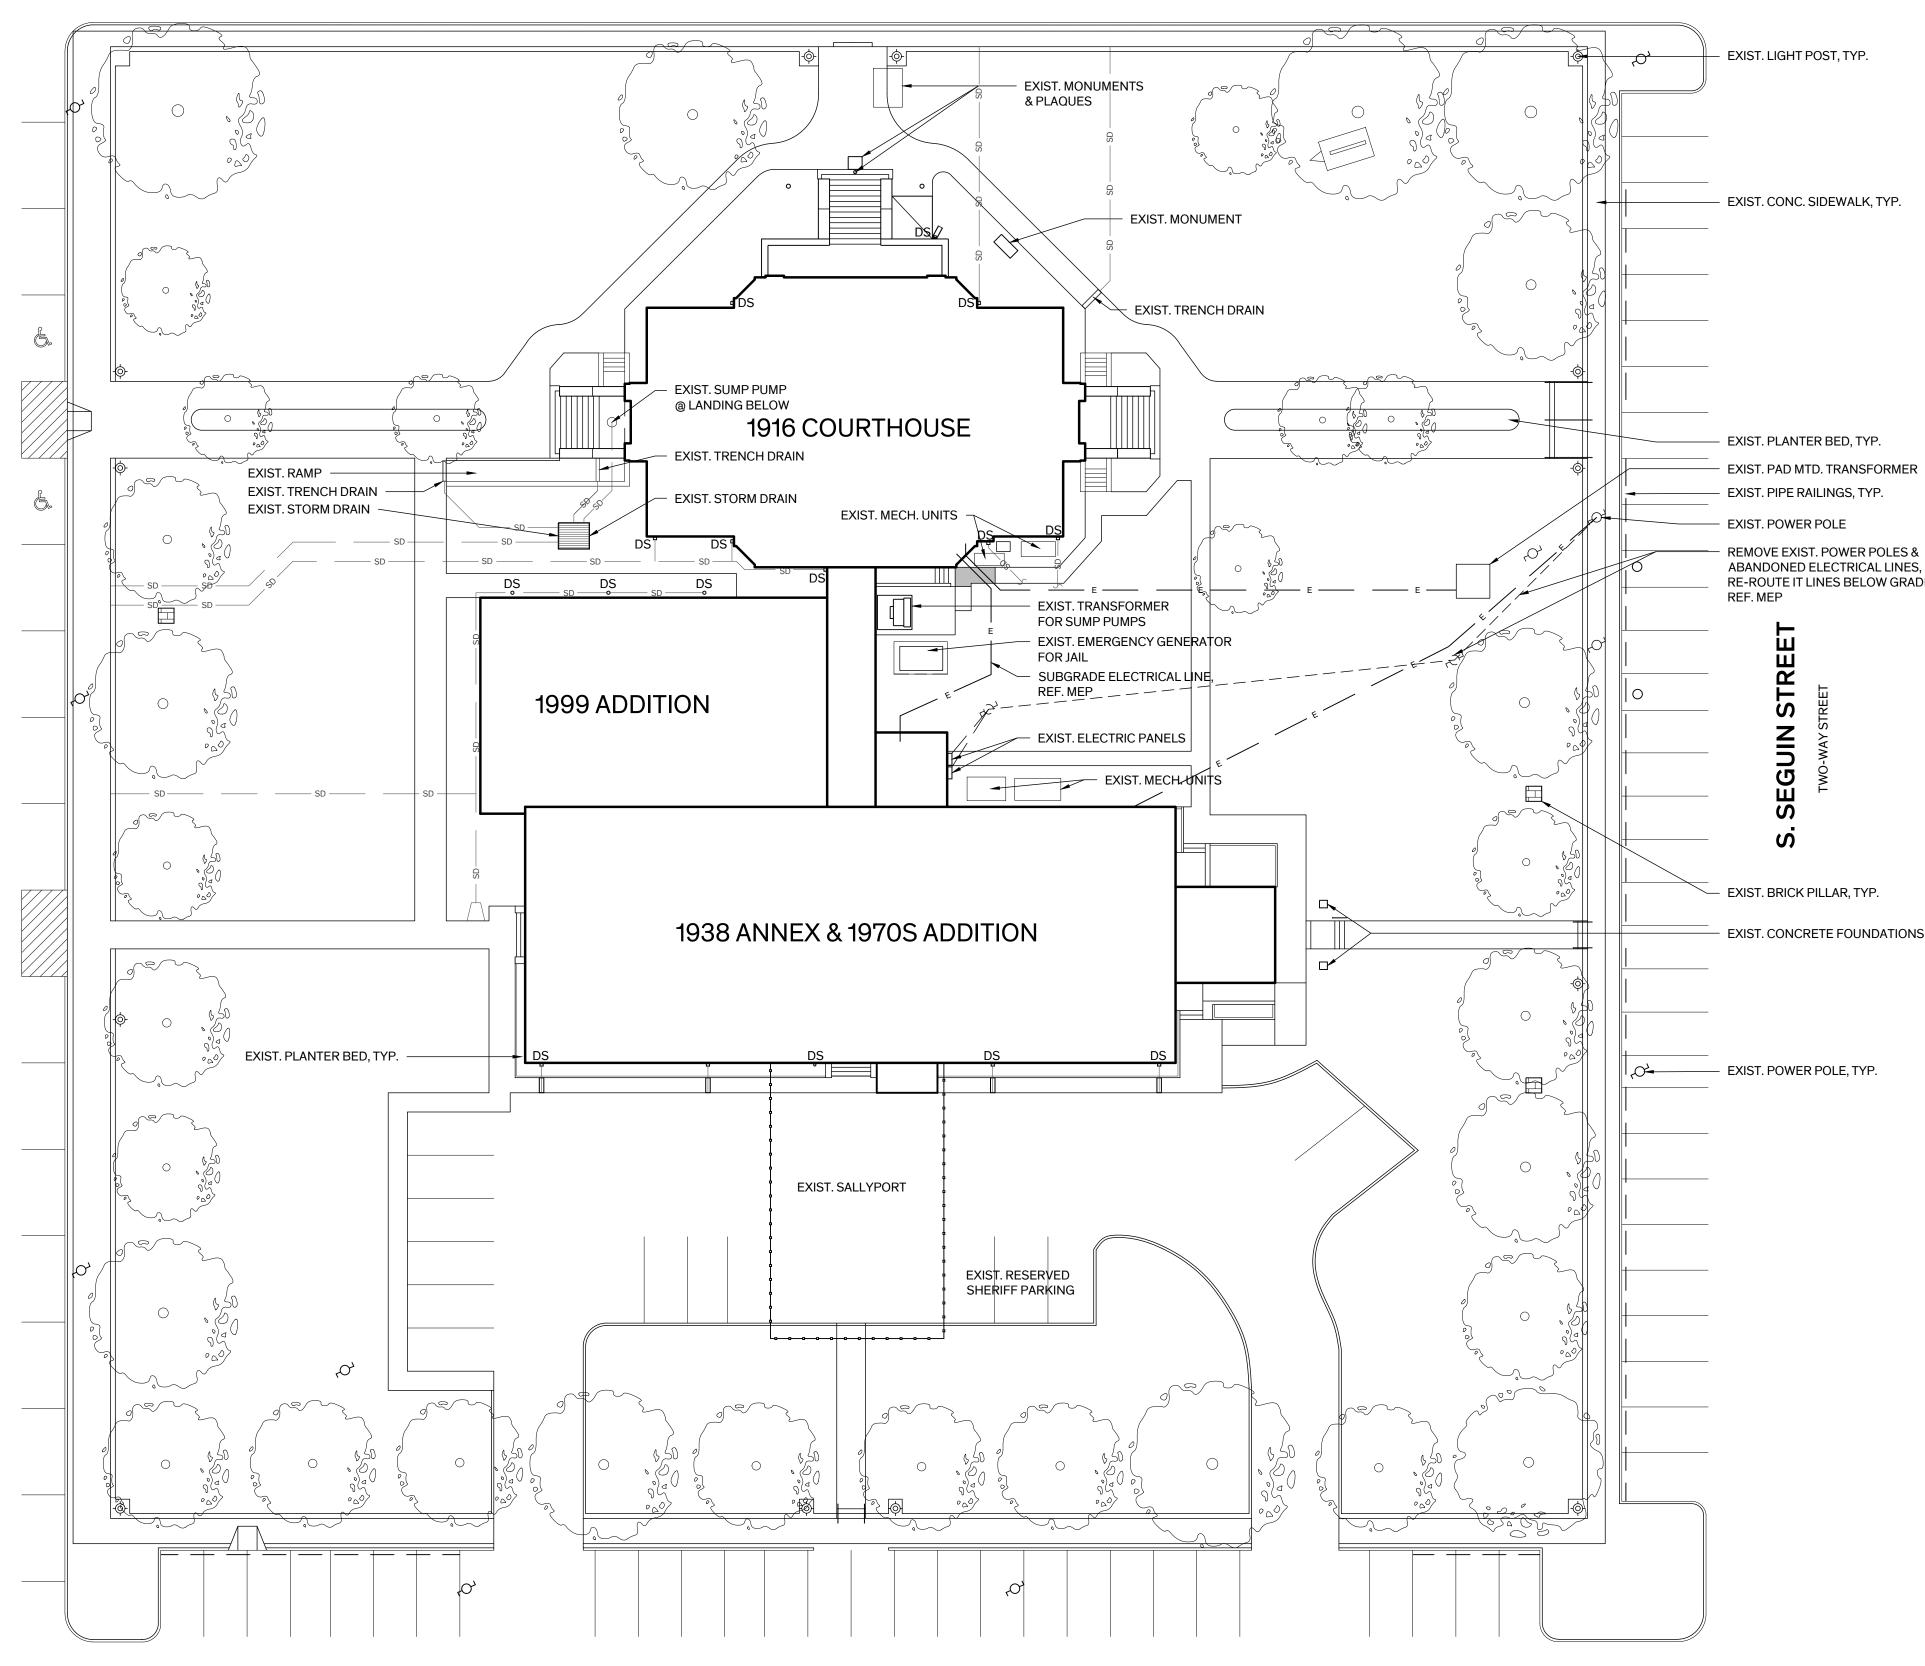

REET S R 4 BEX ົ່

### **E. GRAVIS AVENUE** TWO-WAY STREET

**E. COLLINS AVENUE** TWO-WAY STREET





### **GENERAL NOTES - SITE PLAN** Architexas 1. GENERAL SITE WORK A. UTILITY LOCATIONS ARE APPROXIMATE, V.I.F. LOCATE GAS, WATER, Austin | Dallas 1023 Springdale Rd. ELECTRICAL, & OTHER MISC. UTILITY LINES PRIOR TO TRENCHING. San Antonio Bldg. 11, Suite E www.architexas.com Austin, Texas 78721 B. REFERENCE ELECTRICAL FOR SCOPE OF ELECTRICAL REHABILITATION WORK. p 512.444.4220 . MONUMENTS, MARKER: PROVIDE TEMPORARY PROTECTION FOR EXISTING MONUMENTS & RTHL MARKERS DURING CONSTRUCTION ACTIVITIES ON SITE. . TREE PROTECTION: PROTECT EXIST. TREES & ROOT SYSTEMS DURING EXCAVATING & BACKFILLING OPERATIONS. IF TREES ARE DAMAGED BY CONSTRUCTION OPERATIONS, CONTRACTOR SHALL OBTAIN THE SERVICES OF A CERTIFIED ARBORIST TO PERFORM REPAIRS AT NO ADDITIONAL COST TO THE OWNER. SIDEWALK REPLACEMENT: A. SIDEWALKS SHALL AVE A SLOPE NO GREATER THAN 5% & A CROSS SLOPE OF NOT GREATER THAN 2% UNLESS OTHERWISE NOTED. NEW SIDEWALKS SHALL MATCH EXIST. HISTORIC SIDEWALK IN COMPOSITION, COLOR, FINISH, & JOINT TOOLING. PROVIDE EXPANSION JOINTS MAX. 20'-0"; PROVIDE CONTROL JOINTS MAX. 5'-0". **B.** REPLACE SIDEWALK AS REQUIRED WHERE BELOW GRADE UTILITY LINES ARE SCHEDULED, REFER TO SHT. A-1.02 FOR TYPICAL SIDEWALK DETAILS. S. SITE RESTORATION: RESTORE DAMAGE TO EXIST. LANDSCAPING SCHEDULED TO REMAIN ADJACENT TO AREA OF WORK INCLUDING BUT NOT LIMITED TO SIDEWALKS, PLANTING BEDS, CURBS, LAWN, ETC... RESULTING FROM THE WORK OF THIS CONTRACT INCLUDING BUT NOT LIMITED TO THE FOLLOWING: SUB-SURFACE UTILITY WORK, ELECTRICAL REHABILITATION WORK, MASONRY & WINDOW RESTORATION WORK, ETC ... . IRRIGATION:

A. THE SITE HAS AN EXIST. IRRIGATION SYSTEM THAT IS TO REMAIN IN

B. CONTRACTOR TO DOCUMENT THE LOCATION OF ALL EXIST. SPRINKLER VALVES, HEADS, PIPING, & OTHER ACCESSORIES & PROTECT FROM

C. RESTORE DAMAGE TO EXIST. IRRIGATION SYSTEM RESULTING FROM

6. ELECTRICAL REHABILITATION: REF. ELECTRICAL DRAWINGS


PLACE.

DAMAGE.

WORK OF THIS CONTRACT.

REMOVE EXIST. POWER POLES & ABANDONED ELECTRICAL LINES, RE-ROUTE IT LINES BELOW GRADE,

- EXIST. CONCRETE FOUNDATIONS

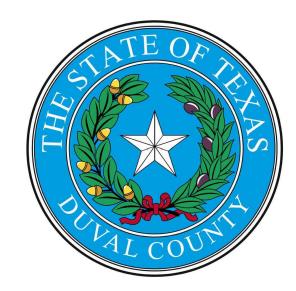

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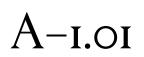
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Architexas No. 2433 Sheet Name


Date 6/19/2025

SITE PLAN


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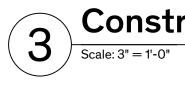



# LEGEND

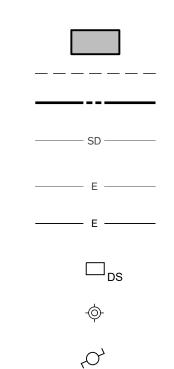

NEW CONCRETE SIDEWALK
ELEMENT TO BE REMOVED
PROPERTY LINE
EXIST. SUBSURFACE DOWNSPOUT OR TRENCH DRAIN LINES
EXIST. SUBSURFACE ELECTRICAL LINES
NEW SUBSURFACE ELECTRICAL LINES
EXIST. DOWNSPOUT
EXIST. LAMP POSTS
EXIST. UTILITY POLE



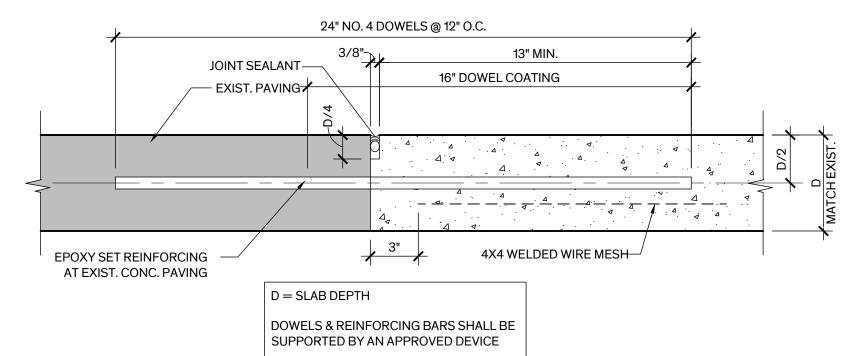

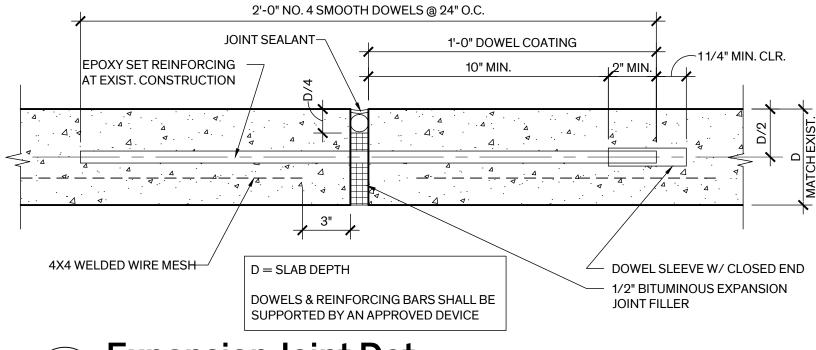



TOOLED JOINT TO MATCH EXISTING PROFILE AND JOINT PATTERN.

<	



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**Architexas No.** 2433 Sheet Name

Date

A-1.02

SITE DETAILS

Sheet Number

6/19/2025

4X4 WELDED WIRE MESH-Δ Δ Δ ... . ⊿ · 4 Δ. 

D = SLAB DEPTH

ALL JOINTS TO BE CUT W/ EARLY ENTRY DRY CUT SAW. & IMMEDIATELY AFTER INITIAL SET OF THE CONC. @ JOINT LOCATION.


# **Expansion Joint Det.**

. \_\_\_\_\_

. ₹

# **Construction Joint Det.**

# DUVAL COUNTY

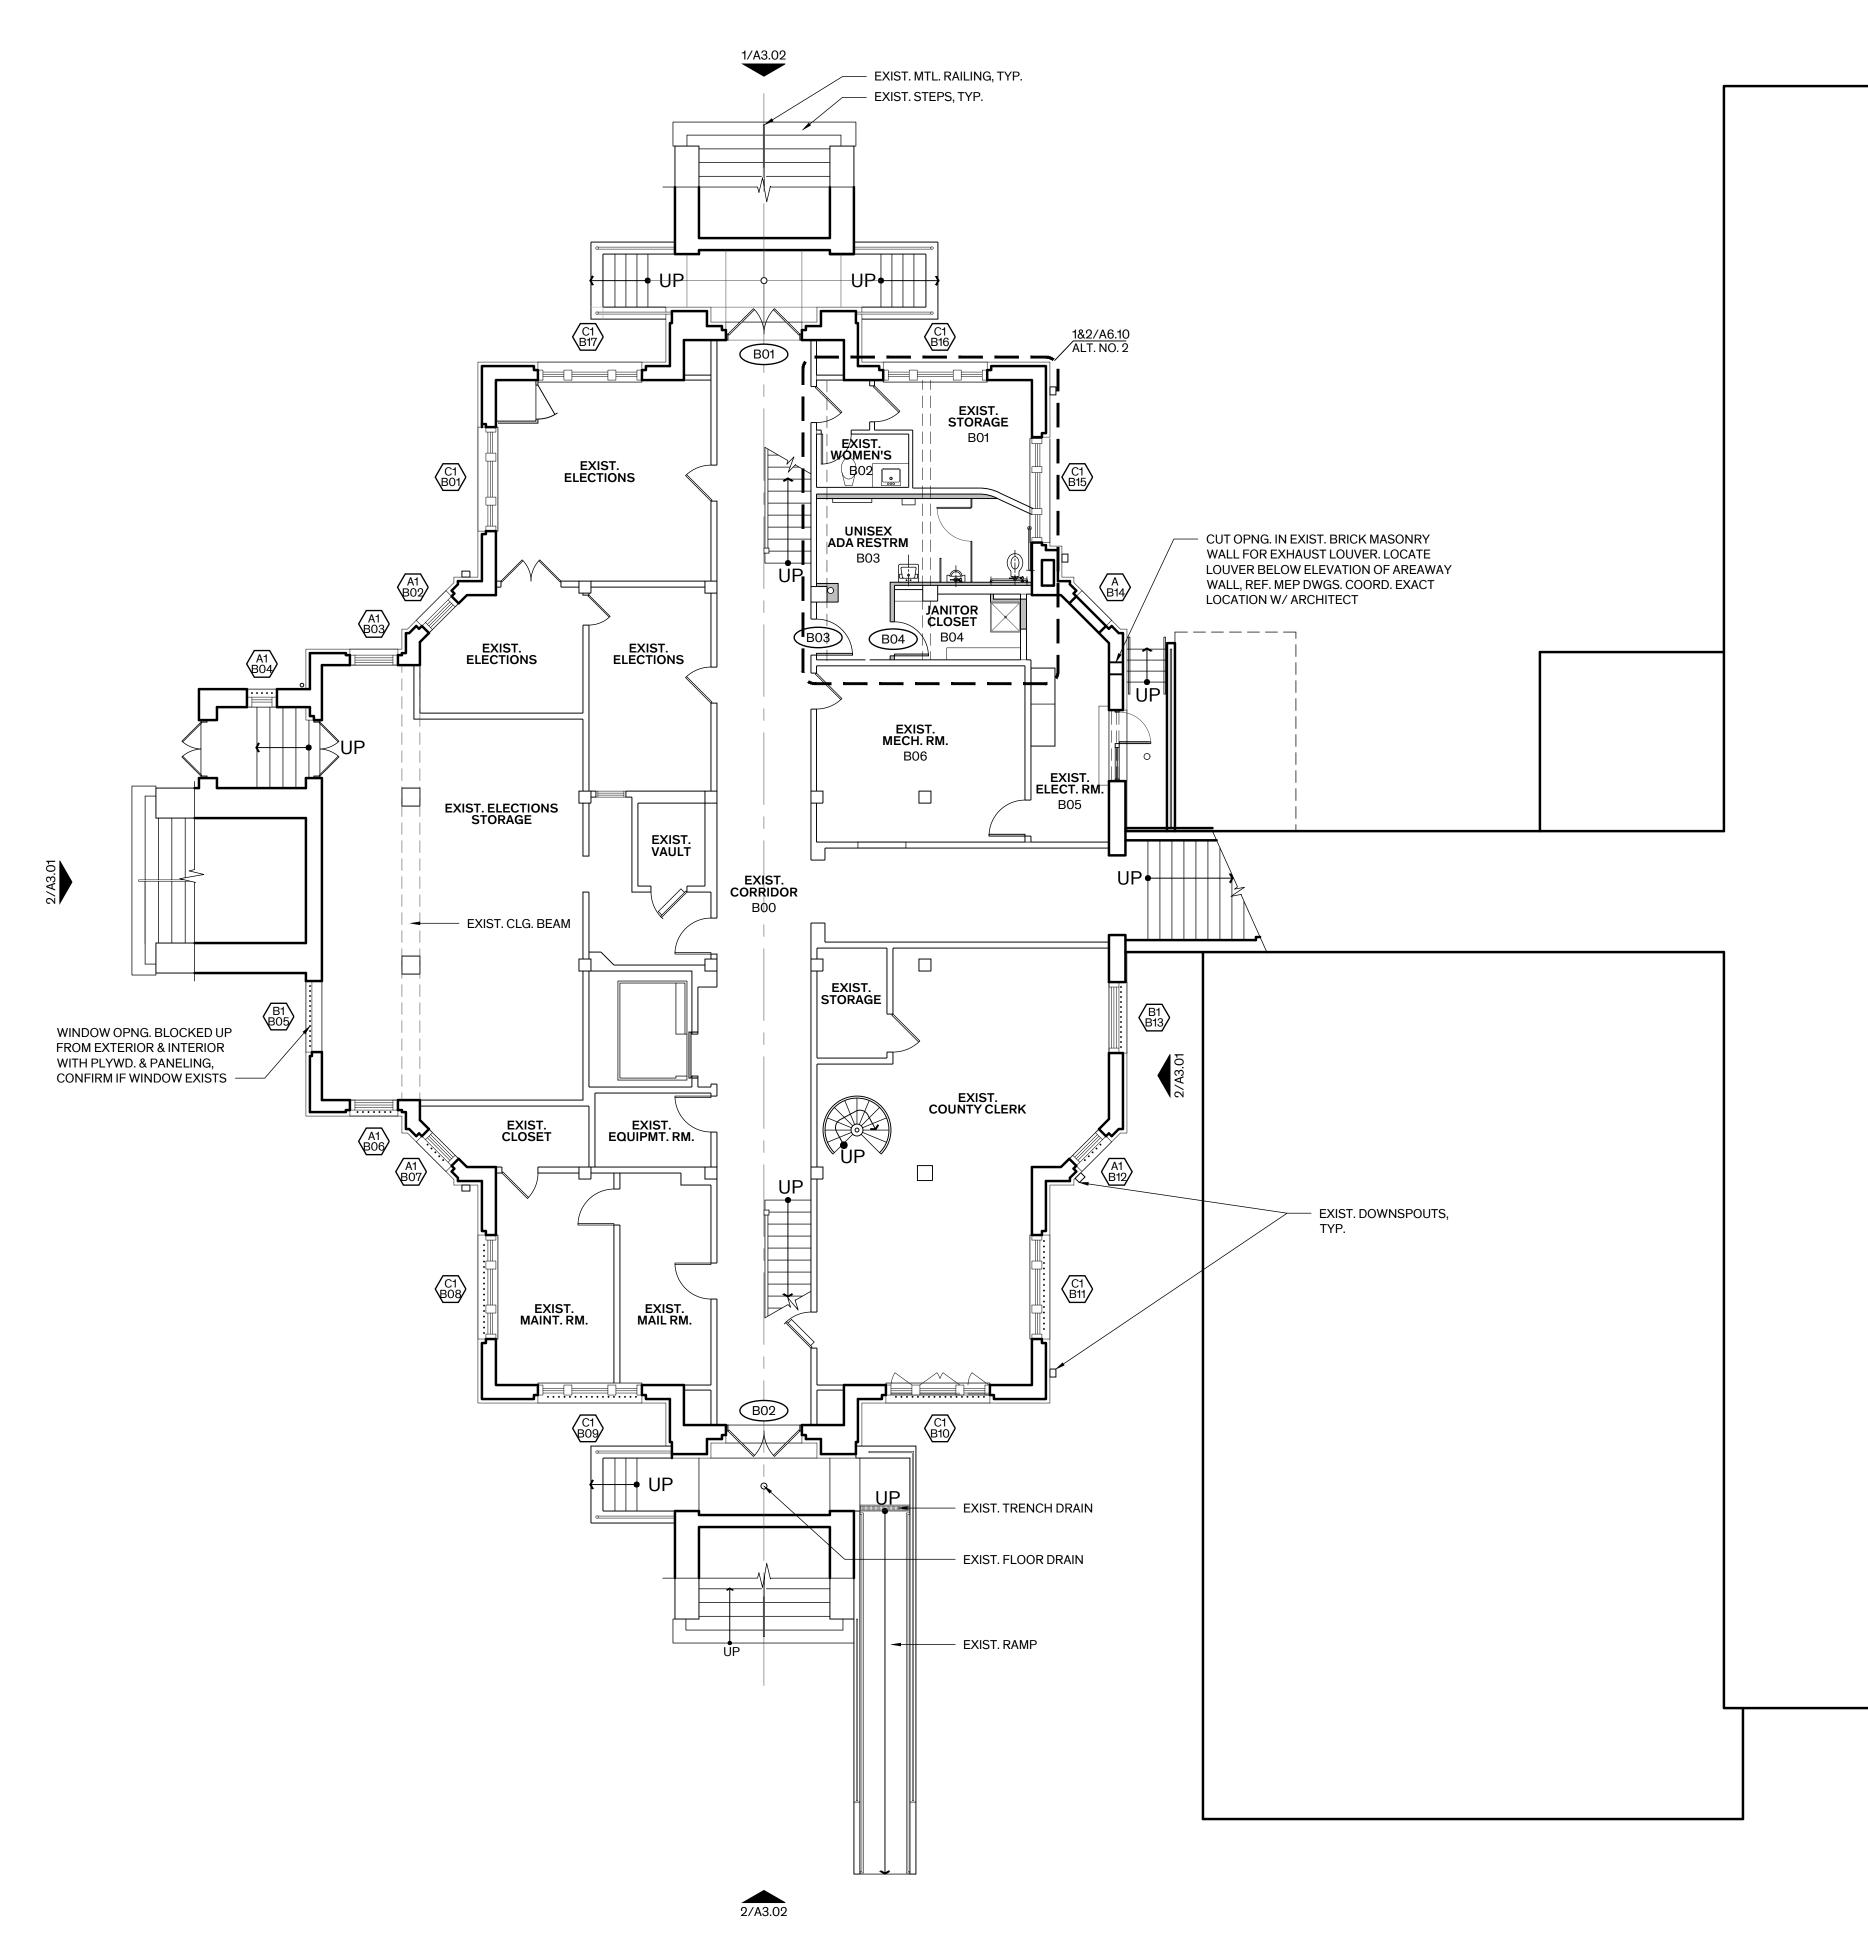



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	GENERAL NOTES - PLANS
1.	<ul> <li>GENERAL:</li> <li>A. IN AREAS OF WORK, COORDINATE TEMPORARY RELOCATION OF FURNISHINGS &amp; STORED ITEMS WITH OWNER AS REQUIRED TO PROPERLY ACCESS &amp; COMPLETE WORK</li> <li>B. PROVIDE TEMPORARY PROTECTION IN AREAS OF WORK AS REQ'D TO PREVENT DAMAGE TO ADJACENT CONSTRUCTION/FINISHES SCHEDULED TO REMAIN.</li> </ul>
	<ul> <li>C. PROVIDE TEMPORARY PROTECTION/BARRIERS IN AREAS OF WORK AS REQ'D TO MINIMIZE SPREAD OF DUST &amp; DEBRIS.</li> <li>D. WHERE REMOVAL OF ORIGINAL MATERIAL IS SCHEDULED, SALVAGE &amp; RETURN TO OWNER WHERE INDICATED.</li> <li>E. COORDINATE POTENTIAL POWER/SERVICE OUTAGES WITH OWNER. PROVIDE MINIMUM 48 HOURS NOTICE PRIOR TO OUTAGE.</li> </ul>
2.	<ul> <li>EXTERIOR WINDOWS &amp; WINDOW GRILLES:</li> <li>B. RESTORE WOOD WINDOW ASSEMBLIES AT THE BASEMENT LEVEL U.O.N. REMOVE &amp; REINSTALL GRILLES AS REQUIRED TO ACCESS WINDOW TO COMPLETE WORK. REFER TO WINDOW SCHEDULE &amp; GENERAL NOTES ON SHEET A-5.10 FOR SCOPE OF WORK.</li> <li>C. REMOVE TEMPORARY PLYWD. PROTECTION &amp; OR INTERIOR FINISHES TO ACCESS WINDOW ASSEMBLY &amp; DISPOSE.</li> <li>D. ASSUME ALL WINDOW ASSEMBLIES EXIST &amp; SHALL BE RESTORED AS INDICATED.</li> </ul>
	DOORS: REFER TO DOOR SCHEDULE ON SHEET A-5.01 FOR SCOPE OF WORK.
	<ul> <li>A. REMOVE DUST &amp; DEBRIS, REMOVE BATT INSULATION 100%, REMOVE ABANDONED CABLING, CONDUIT, WIRING, ETC, LEAVE VACUUM CLEAN.</li> <li>B. REPLACE BATT INSULATION, PROVIDE BETWEEN CEILING FRAMING THROUGHOUT.</li> </ul>
5.	<b>SEALANT:</b> REPLACE SEALANT AT PERIMETER OF DOOR & WINDOW OPENINGS AT ASSEMBLIES SCHEDULED TO BE RESTORED & ELSEWHERE WHERE INDICATED ON THE DRAWINGS.
6.	ELECTRICAL REHABILITATION: REF. ELECTRICAL DRAWINGS A. NEW CONDUIT & DEVICES SHALL NOT BE EXPOSED IN PUBLIC & SECONDARY SPACES. EXPOSED CONDUIT & DEVICES ARE ACCEPTABLE IN MECHANICAL & ELECTRICAL ROOMS, JANITOR'S CLOSET, & ATTIC. DO NOT RUN CONDUIT/WIRE EXPOSED ON FACE OF BUILDING
7.	<b>MEP:</b> REMOVE & REINSTALL MEP DEVICES & DISTRIBUTION LINES INCLUDING SECURITY, IT, & LIGHTNING PROTECTION, AS REQUIRED TO COMPLETE THE WORK OF THIS CONTRACT. REMOVE ABANDONED DEVICES & LINES IN AREA OF WORK, CAP ENDS U.O.N.
8.	HAZARDOUS MATERIALS ABATEMENT: REFER TO LEAD PAINT REMOVAL WORK PLAN & ASBESTOS ABATEMENT PROJECT DESIGN IN THE APPENDIX OF THE PROJECT MANUAL FOR SCOPE OF WORK
-	
_[	_EGEND
	EXIST. WALLS TO REMAIN

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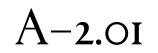


**Architexas No.** 2433

Date 6/19/2025

Sheet Name BASEMENT FLOOR PLAN

Sheet Number




# ALTERNATES


REFER TO SPEC. SECTION 01230 - ALTERNATES FOR DETAILED DESCRIPTION

ALTERNATE NO. 1: PREP & PAINT EXTERIOR WOOD DOORS, B02, B04, 101, & 103.


ALTERNATE NO. 2: REHABILITATE MEN'S RESTROOM AT BASEMENT LEVEL TO ADA COMPLIANT UNISEX RESTROOM



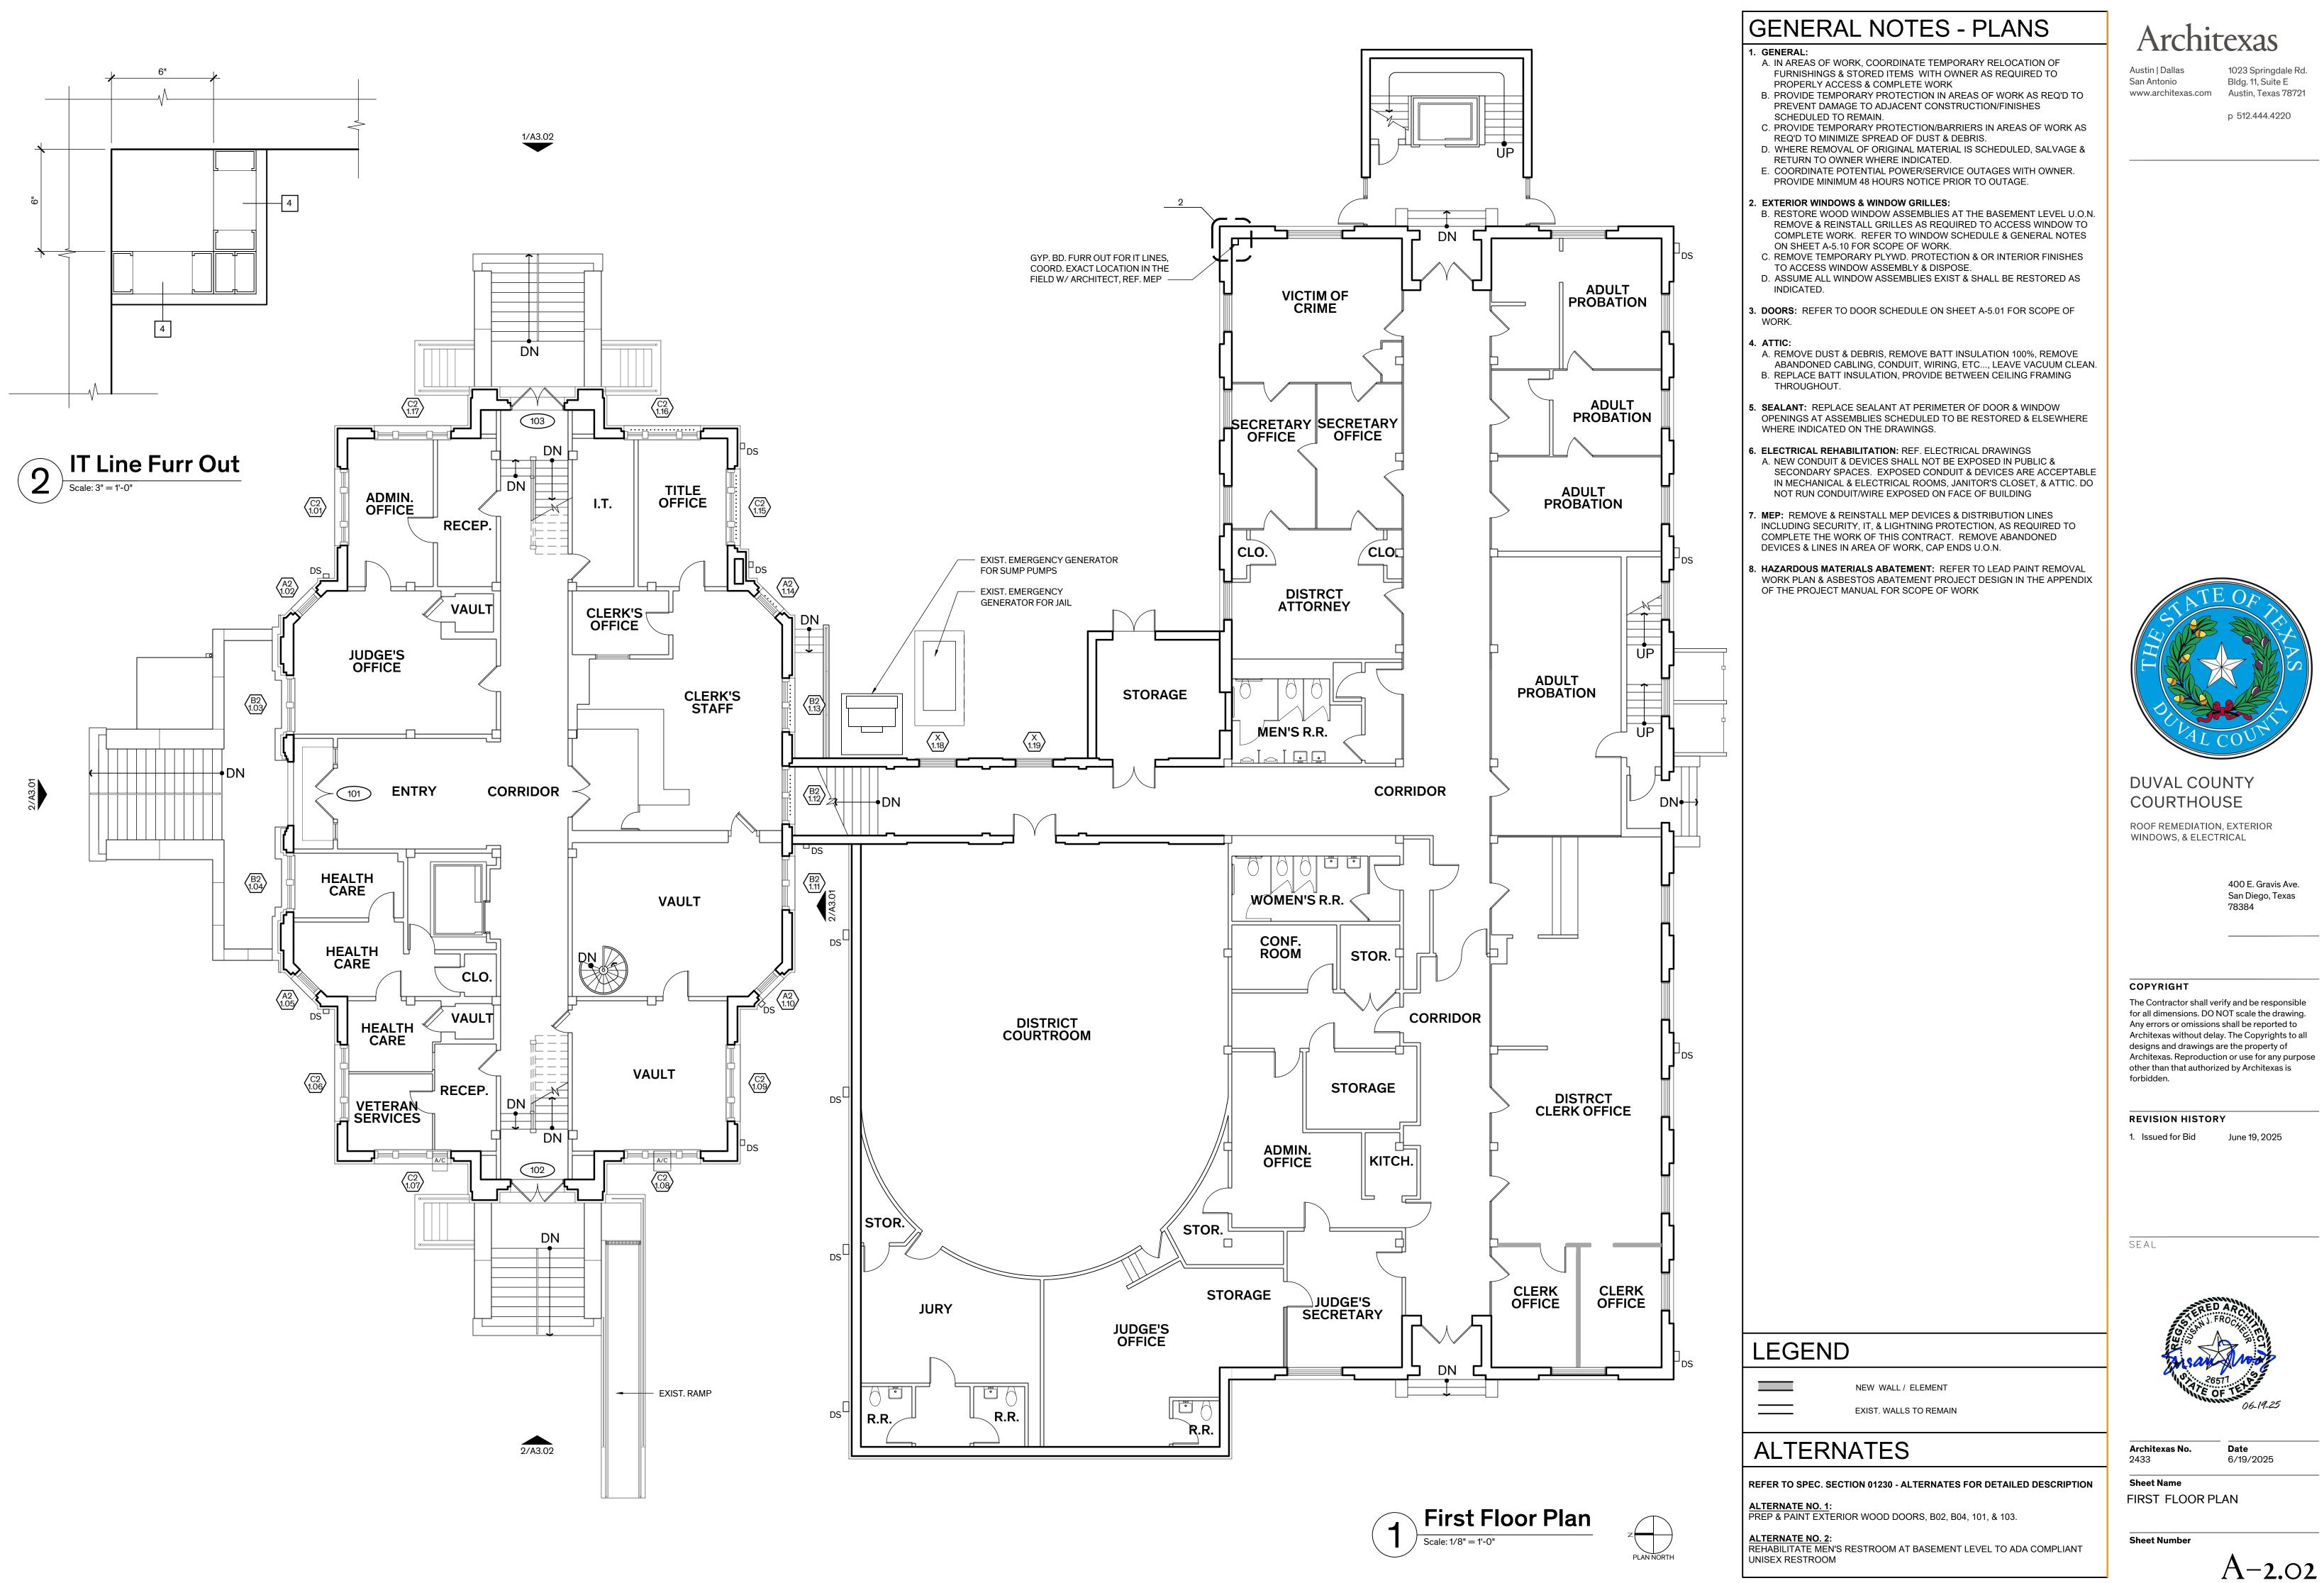

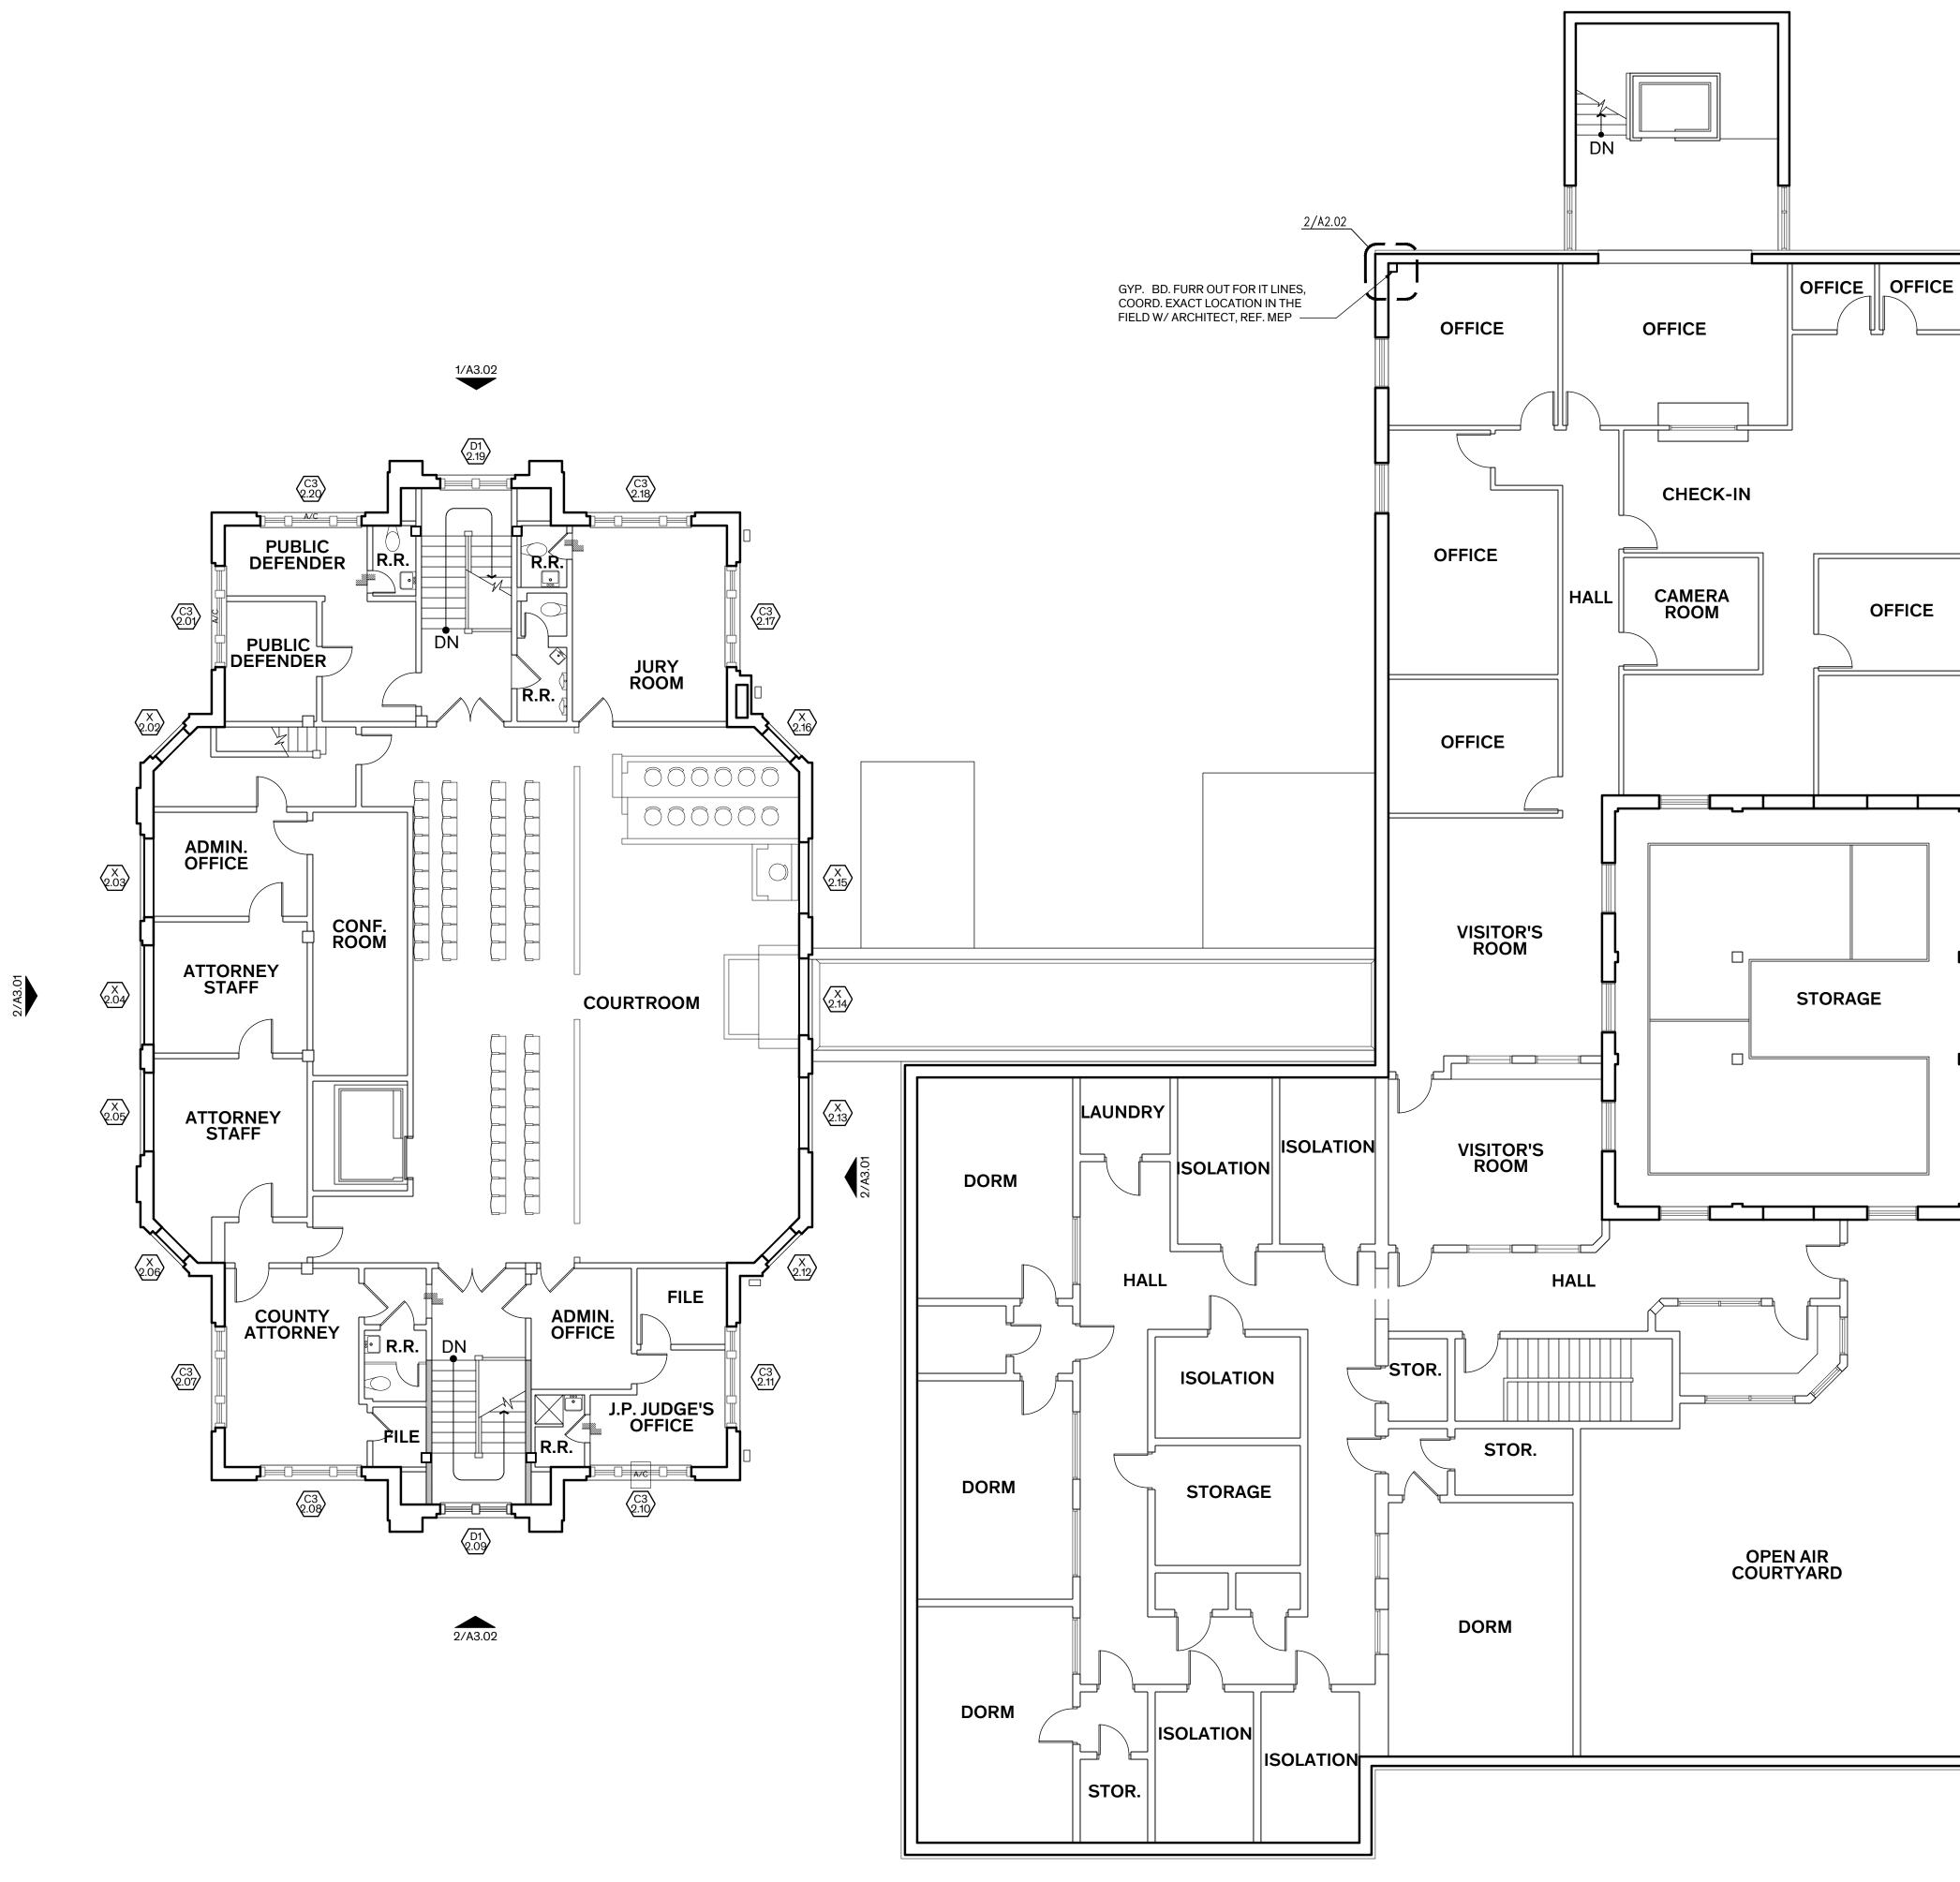

Second Floor Plan  $\int \text{Scale: } 1/8" = 1'-0"$ 

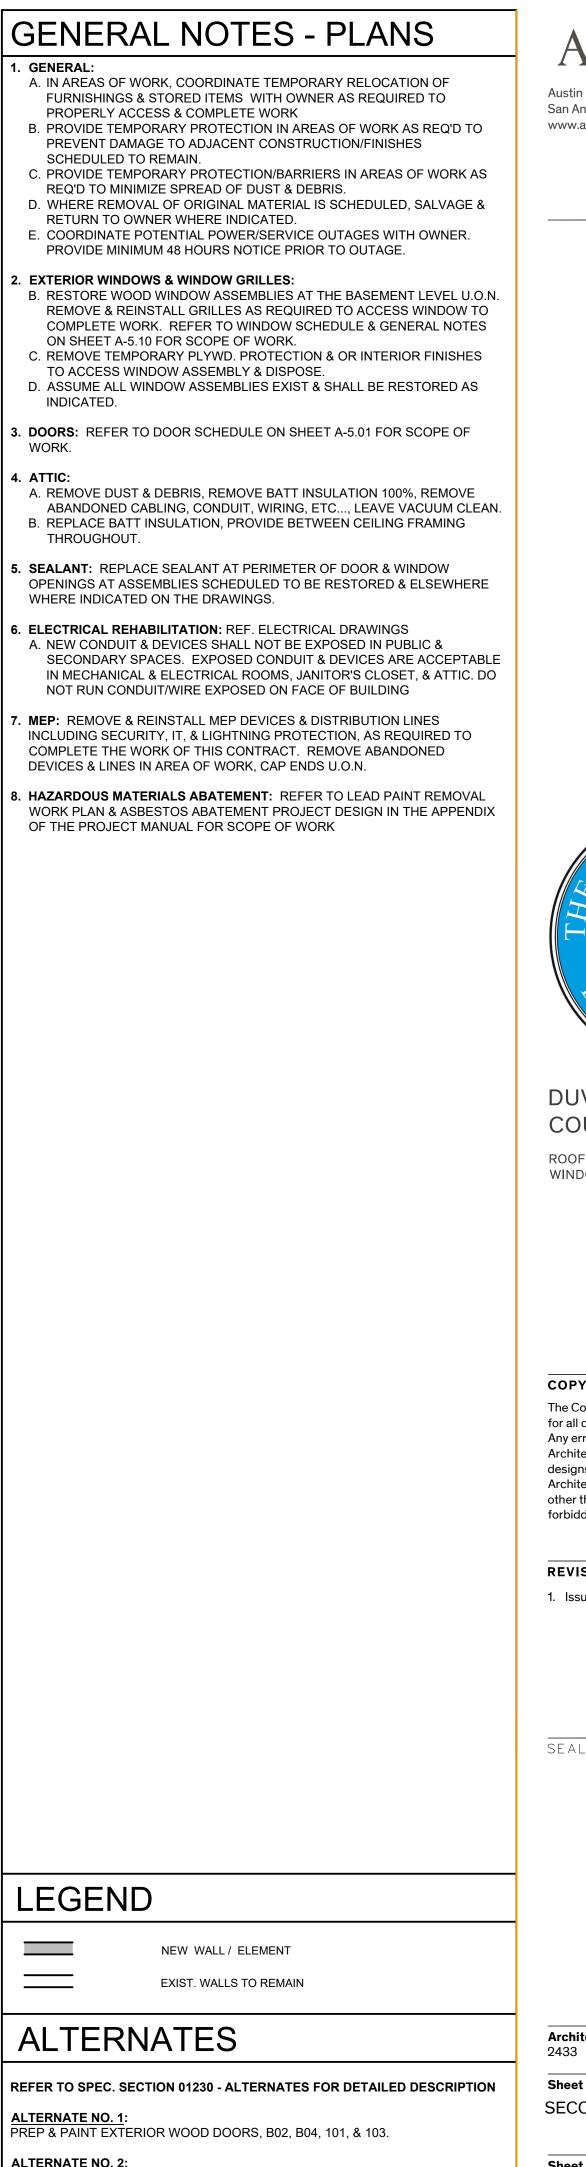

ALTERNATE NO. 2: REHABILITATE MEN'S RESTROOM AT BASEMENT LEVEL TO ADA COMPLIANT UNISEX RESTROOM

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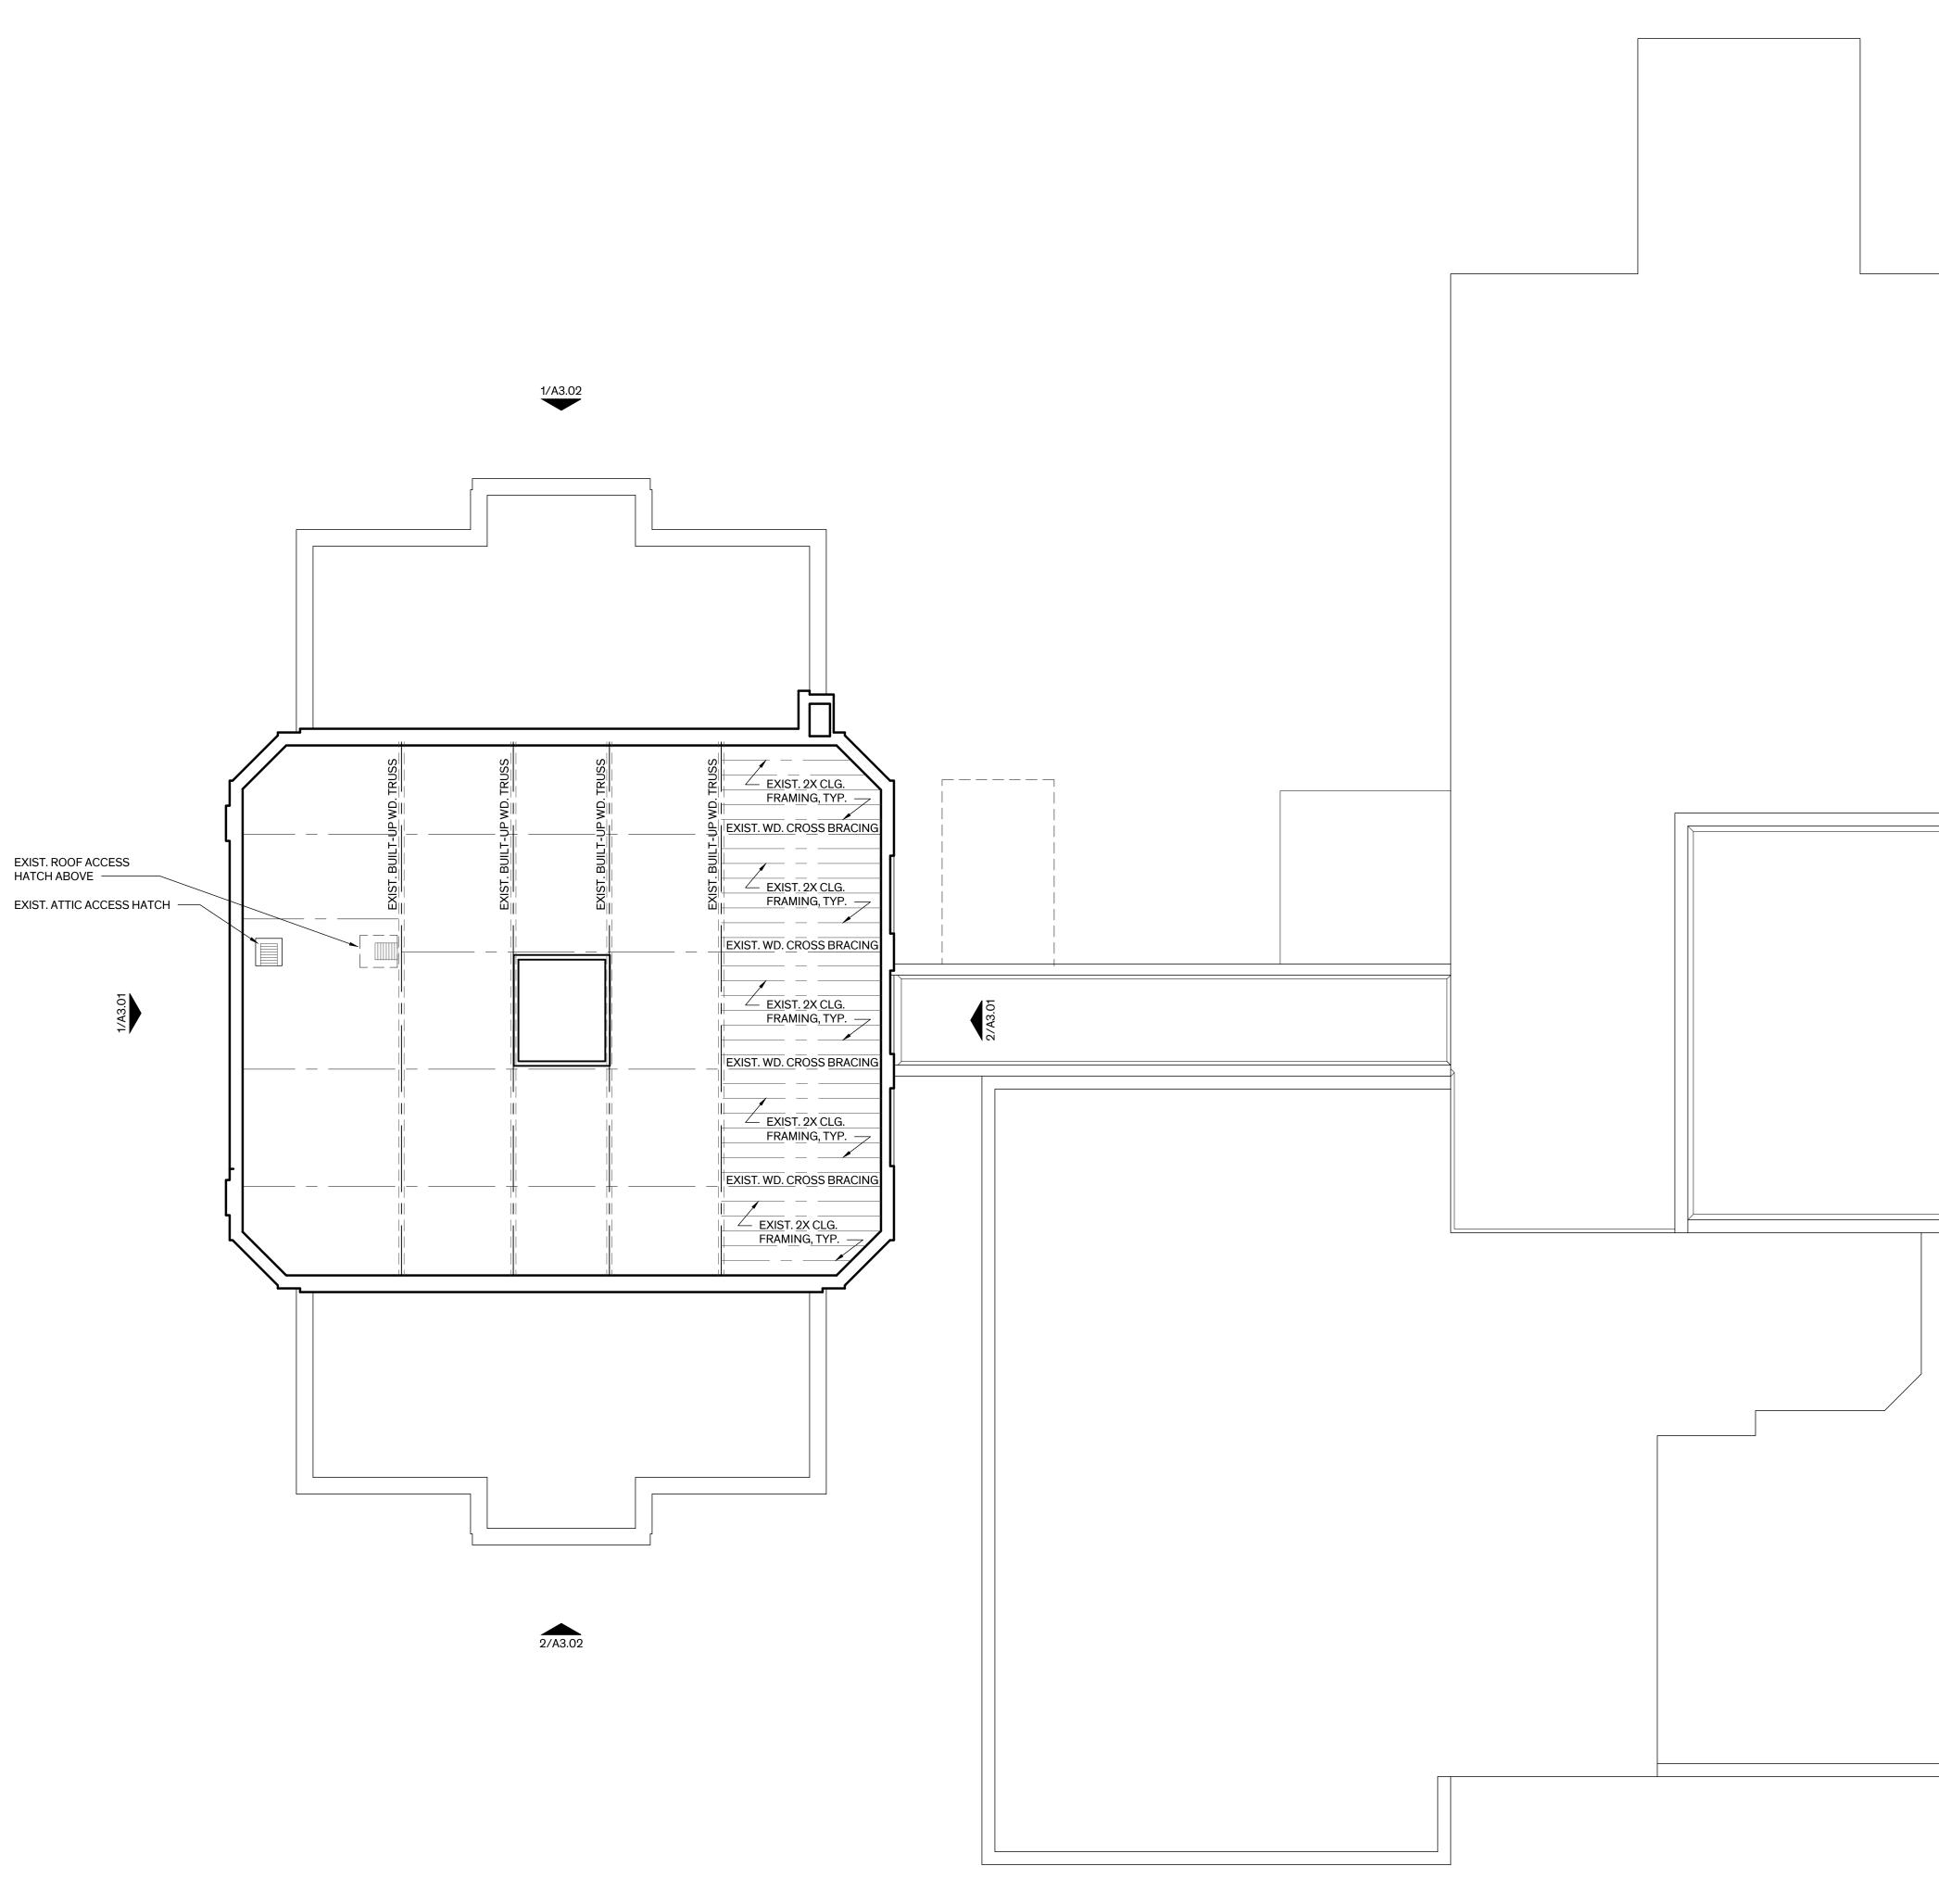
Date 6/19/2025


Sheet Name SECOND FLOOR PLAN

Sheet Number

A-2.03





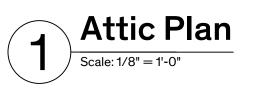



(	GENERAL NOTES - PLANS	
1.	<ul> <li>GENERAL:</li> <li>A. IN AREAS OF WORK, COORDINATE TEMPORARY RELOCATION OF FURNISHINGS &amp; STORED ITEMS WITH OWNER AS REQUIRED TO PROPERLY ACCESS &amp; COMPLETE WORK</li> <li>B. PROVIDE TEMPORARY PROTECTION IN AREAS OF WORK AS REQ'D TO PREVENT DAMAGE TO ADJACENT CONSTRUCTION/FINISHES SCHEDULED TO REMAIN.</li> <li>C. PROVIDE TEMPORARY PROTECTION/BARRIERS IN AREAS OF WORK AS REQ'D TO MINIMIZE SPREAD OF DUST &amp; DEBRIS.</li> <li>D. WHERE REMOVAL OF ORIGINAL MATERIAL IS SCHEDULED, SALVAGE &amp; RETURN TO OWNER WHERE INDICATED.</li> <li>E. COORDINATE POTENTIAL POWER/SERVICE OUTAGES WITH OWNER. PROVIDE MINIMUM 48 HOURS NOTICE PRIOR TO OUTAGE.</li> </ul>	A S w
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7.	<b>MEP:</b> REMOVE & REINSTALL MEP DEVICES & DISTRIBUTION LINES INCLUDING SECURITY, IT, & LIGHTNING PROTECTION, AS REQUIRED TO COMPLETE THE WORK OF THIS CONTRACT. REMOVE ABANDONED DEVICES & LINES IN AREA OF WORK, CAP ENDS U.O.N.	
8.	HAZARDOUS MATERIALS ABATEMENT: REFER TO LEAD PAINT REMOVAL WORK PLAN & ASBESTOS ABATEMENT PROJECT DESIGN IN THE APPENDIX OF THE PROJECT MANUAL FOR SCOPE OF WORK	
		C TI fo A de A of fo R 1.
	EGEND	
	NEW WALL / ELEMENT	
		_
	ALTERNATES	A 24 
<u>A</u>	<u>TERNATE NO. 1:</u> REP & PAINT EXTERIOR WOOD DOORS, B02, B04, 101, & 103.	A
R	<u>_TERNATE NO. 2</u> : EHABILITATE MEN'S RESTROOM AT BASEMENT LEVEL TO ADA COMPLIANT NISEX RESTROOM	S

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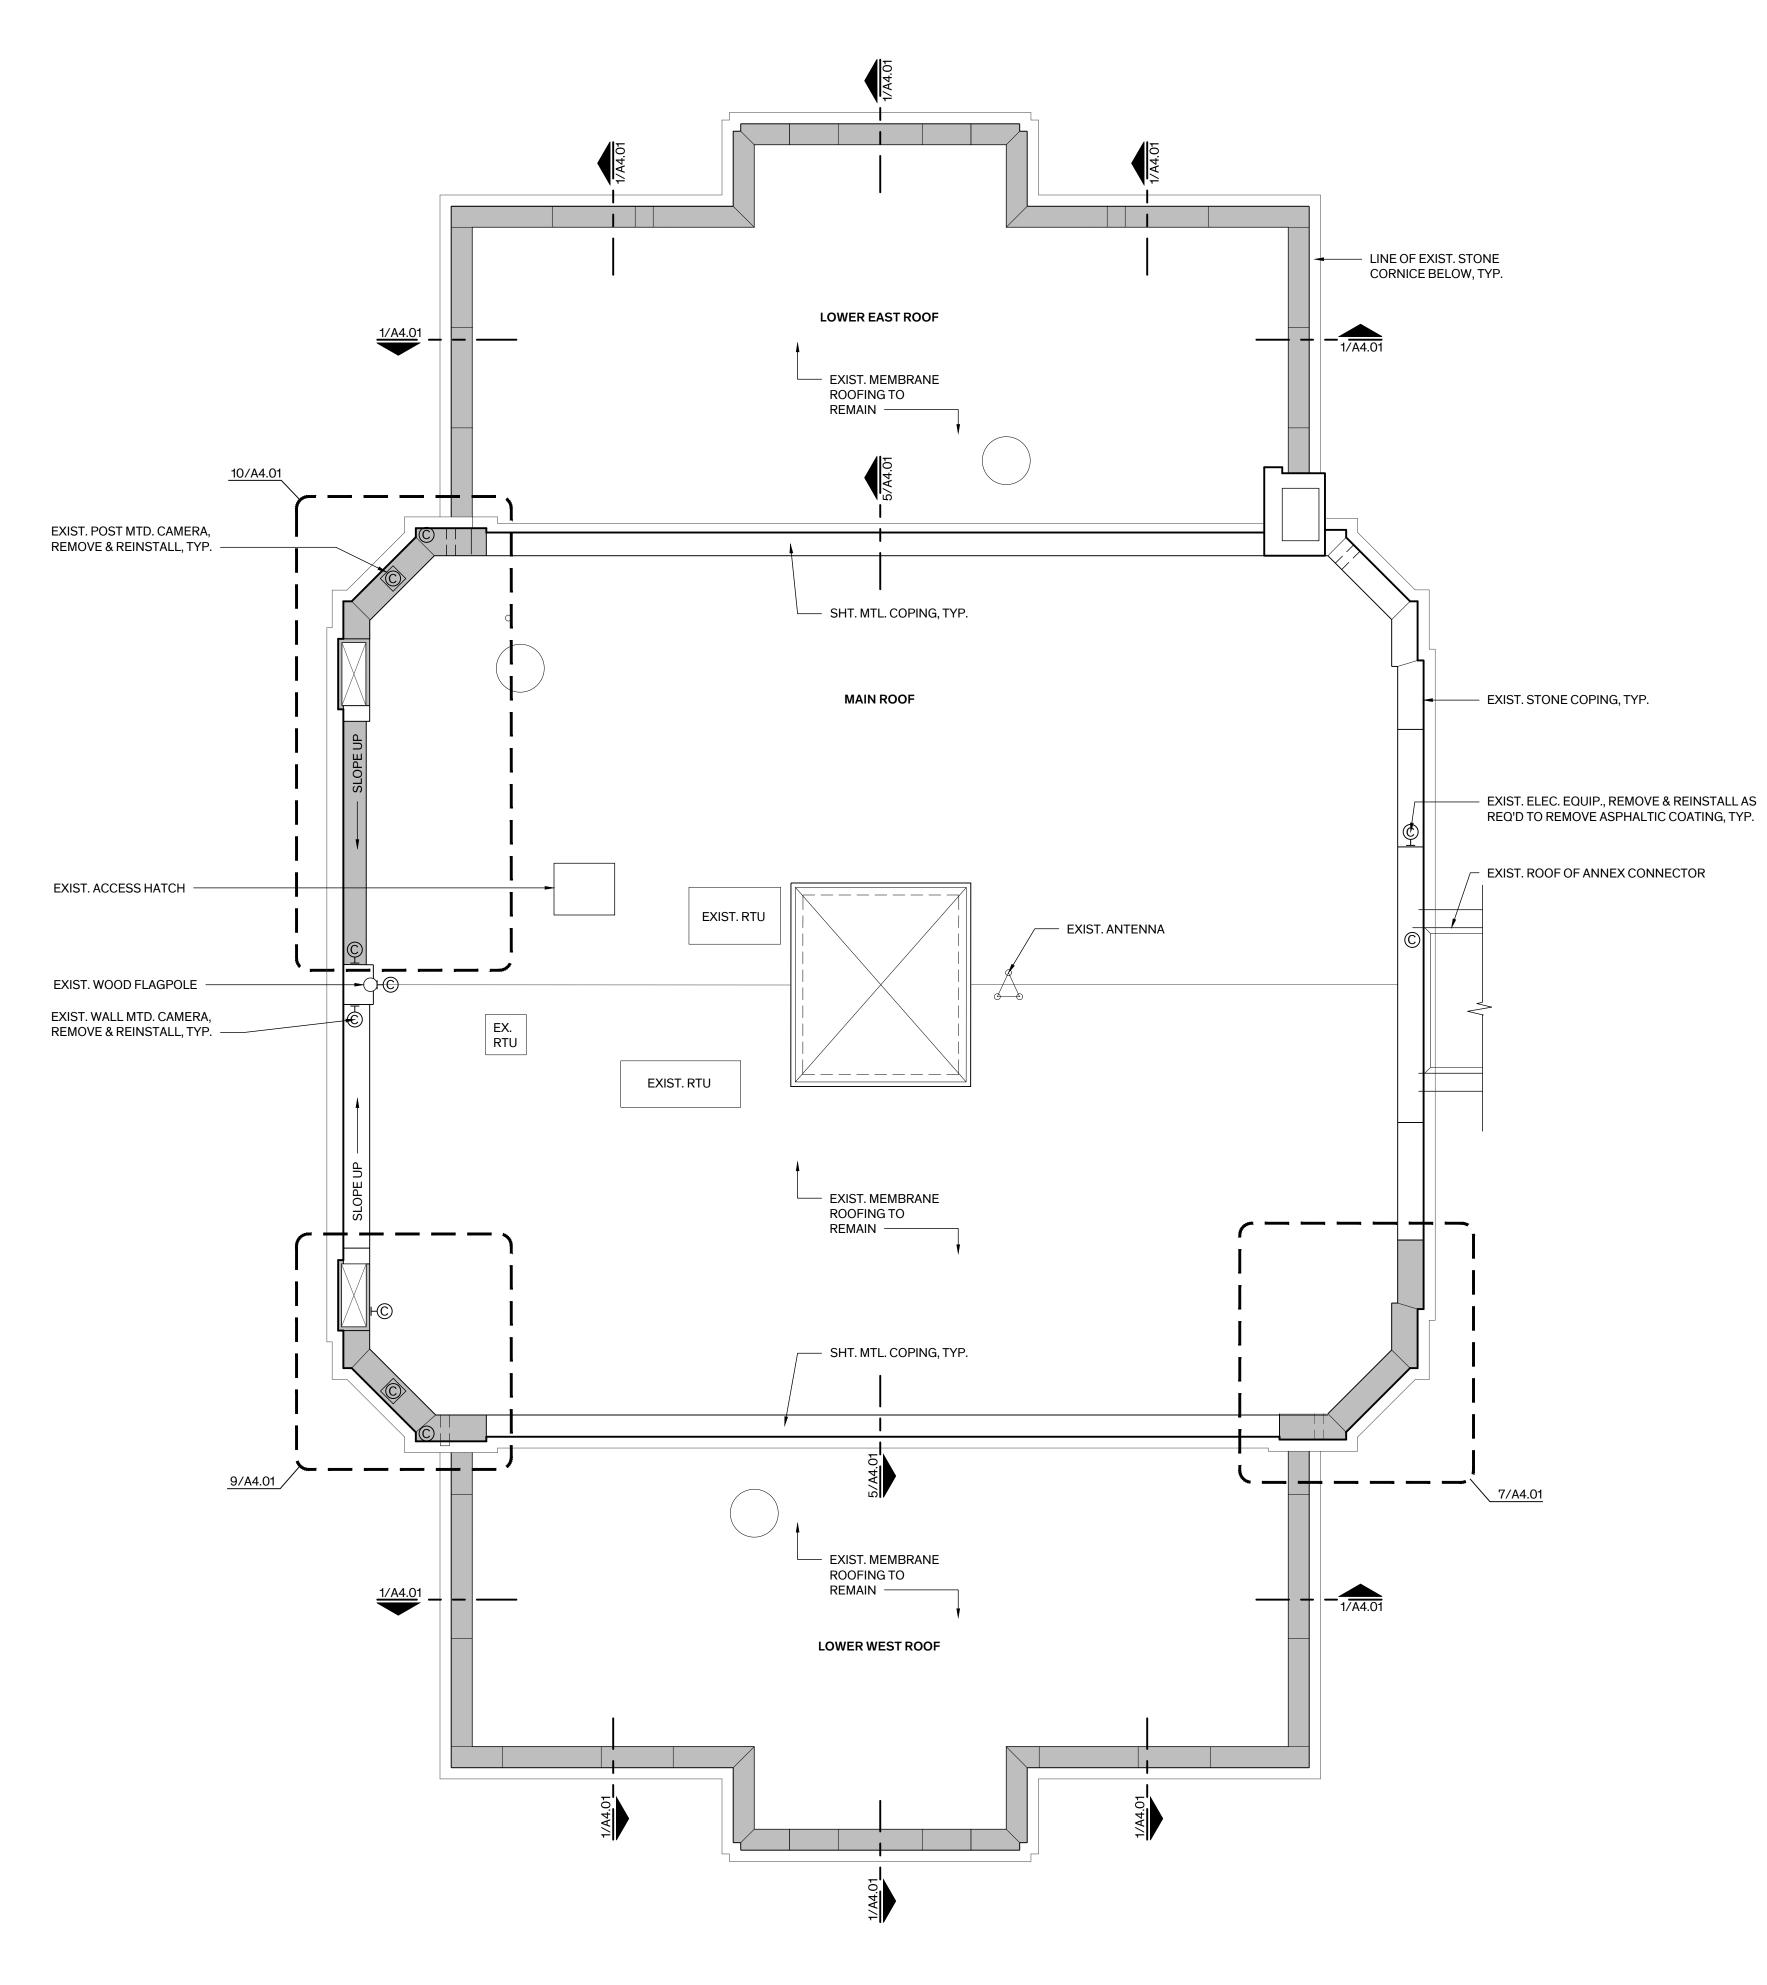
Architexas No. 2433

**Date** 6/19/2025

Sheet Name ATTIC PLAN

Sheet Number

A-2.04



Roof Plan
Scale: 3/16" = 1'-0"



### **GENERAL NOTES - ROOF PLAN 1. PROTECTION:** THE EXIST. MEMBRANE ROOFING SYSTEMS AT THE MAIN

ROOF & EAST & WEST LOWER ROOFS ARE STILL UNDER WARRANTY. FULLY PROTECT ROOFING FOR THE DURATION OF THE PROJECT WITH <sup>1</sup>/<sub>2</sub>" THICK PLYWOOD OVER 1" THICK RIGID INSULATION. THE CONTRACTOR IS RESPONSIBLE FOR REPAIRING DAMAGE TO THE ROOFING RESULTING FROM THE WORK OF THIS CONTRACT AT NO ADDITIONAL COST TO THE OWNER. REPAIRS MUST BE APPROVED BY THE ROOFING MANUFACTURER & SHALL NOT AFFECT THE WARRANTY.

### . COPING STONES:

- A. REMOVE & REPLACE COPING STONES DAMAGED BY FASTENER INSTALLATION FOR PARAPET MEMBRANE FLASHING & TERMINATION BAR. ASSUME COPING STONES SHALL BE REPLACED 100% AT EAST & WEST LOWER ROOFS & SELECTIVELY REPLACED WHERE INDICATED AT MAIN ROOF.
- B. PRIOR TO REMOVAL OF COPING STONES, PROVIDE STONE SHOP DRAWING SUBMITTAL, FULLY DOCUMENTING EACH STONE SCHEDULED FOR REPLACEMENT, INCLUDE PROFILE OF EACH DIFFERENT TYPE OF UNIT, LENGTH OF EACH UNIT, & FINISHED SURFACES. DIMENSIONS & PROFILES OF REPLACEMENT UNITS SHALL MATCH EXISTING EXACTLY. C. PROVIDE SHEET METAL COPING FLASHING BETWEEN COPING STONE &
- BRICK MASONRY PARAPET. D. PROVIDE TWO-PIECE SHEET METAL COUNTERFLASHING REGLETED INTO MORTAR JOINT BETWEEN COPING STONE & BRICK MASONRY PARAPET. TERMINATE PARAPET MEMBRANE FLASHING WITH TERMINATION BAR, FULLY SEALED, UNDERNEATH COUNTERFLASHING
- AS SHOWN. E. AT COPING STONES SCHEDULED TO REMAIN, REMOVE ASPHALTIC COATING & TAR PAPER 100%. CHEMICALLY CLEAN ASPHALT RESIDUE 100% AS SPECIFIED. FOLLOWING COATING REMOVAL, CONTACT ARCHITECT TO REVIEW CONDITION OF STONES & TO VERIFY IF ADDITIONAL REPLACEMENT IS REQUIRED.
- F. PROVIDE LEAD WEATHERCAP AT COPING STONE JOINTS 100%. G. REMOVE & REINSTALL ELEMENTS ON COPING STONES & PARAPET WALLS ASSOCIATED WITH SECURITY, IT, & LIGHTNING PROTECTION SYSTEMS. ENSURE SYSTEMS ARE RESTORED TO CONDITION FOUND AT THE START OF THE PROJECT.
- (1) REINSTALL LIGHTNING PROTECTION CABLING & DEVICES WITH ADHESIVE TYPE PLATES. DO NOT MECHANICALLY FASTEN INTO COPING STONES.
- (2) AT POLE MOUNTED DEVICES WHERE REINSTALLED AT NEW COPING STONES, PRE-DRILL STONE & USE ADHESIVE ANCHORS TO PREVENT DAMAGE. FULLY SET PLATE IN FULL BED OF SEALANT.
- (3) CONTRACTOR SHALL BE RESPONSIBLE FOR REPLACEMENT OF DAMAGED COPING STONES RESULTING FROM REINSTALLATION OF DEVICES WITH MECHANICAL FASTENERS AT NO ADDITIONAL COST TO THE OWNER.
- H. REMOVE & REPLACE FORMED SHEET METAL COPING FLASHING AT EAST & WEST SIDES OF MAIN ROOF PER DET. 5/A-4.01.
- **ELECTRICAL REHABILITATION:** REF. ELECTRICAL DRAWINGS A. MODIFY POWER CONNECTION TO EXIST. CONDENSER UNITS FOR CODE COMPLIANCE.
- B. REMOVE ABANDONED CABLING, CONDUIT, WIRING, ETC... AT MAIN & LOWER ROOFS. PATCH HOLES AT REMOVED ELEMENTS & WHERE THERE IS THE POTENTIAL FOR WATER INFILTRATION AS DETERMINED BY THE ARCHITECT.
- 4. HAZARDOUS MATERIALS ABATEMENT: REFER TO LEAD PAINT REMOVAL WORK PLAN & ASBESTOS ABATEMENT PROJECT DESIGN IN THE APPENDIX OF THE PROJECT MANUAL FOR SCOPE OF WORK.

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### DUVAL COUNTY COURTHOUSE

ROOF REMEDIATION. EXTERIOR WINDOWS, & ELECTRICAL

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### LEGEND

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C

EXIST. POST MTD. CAMERA &/OR IT DEVICE

COPING STONE TO BE REPLACED


EXIST. WALL MTD. CAMERA &/OR IT DEVICE


EXIST. CAMERA MTD. TO PARAPET

Architexas No. 2433 Sheet Name

Date 6/19/2025

ROOF PLAN

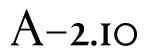

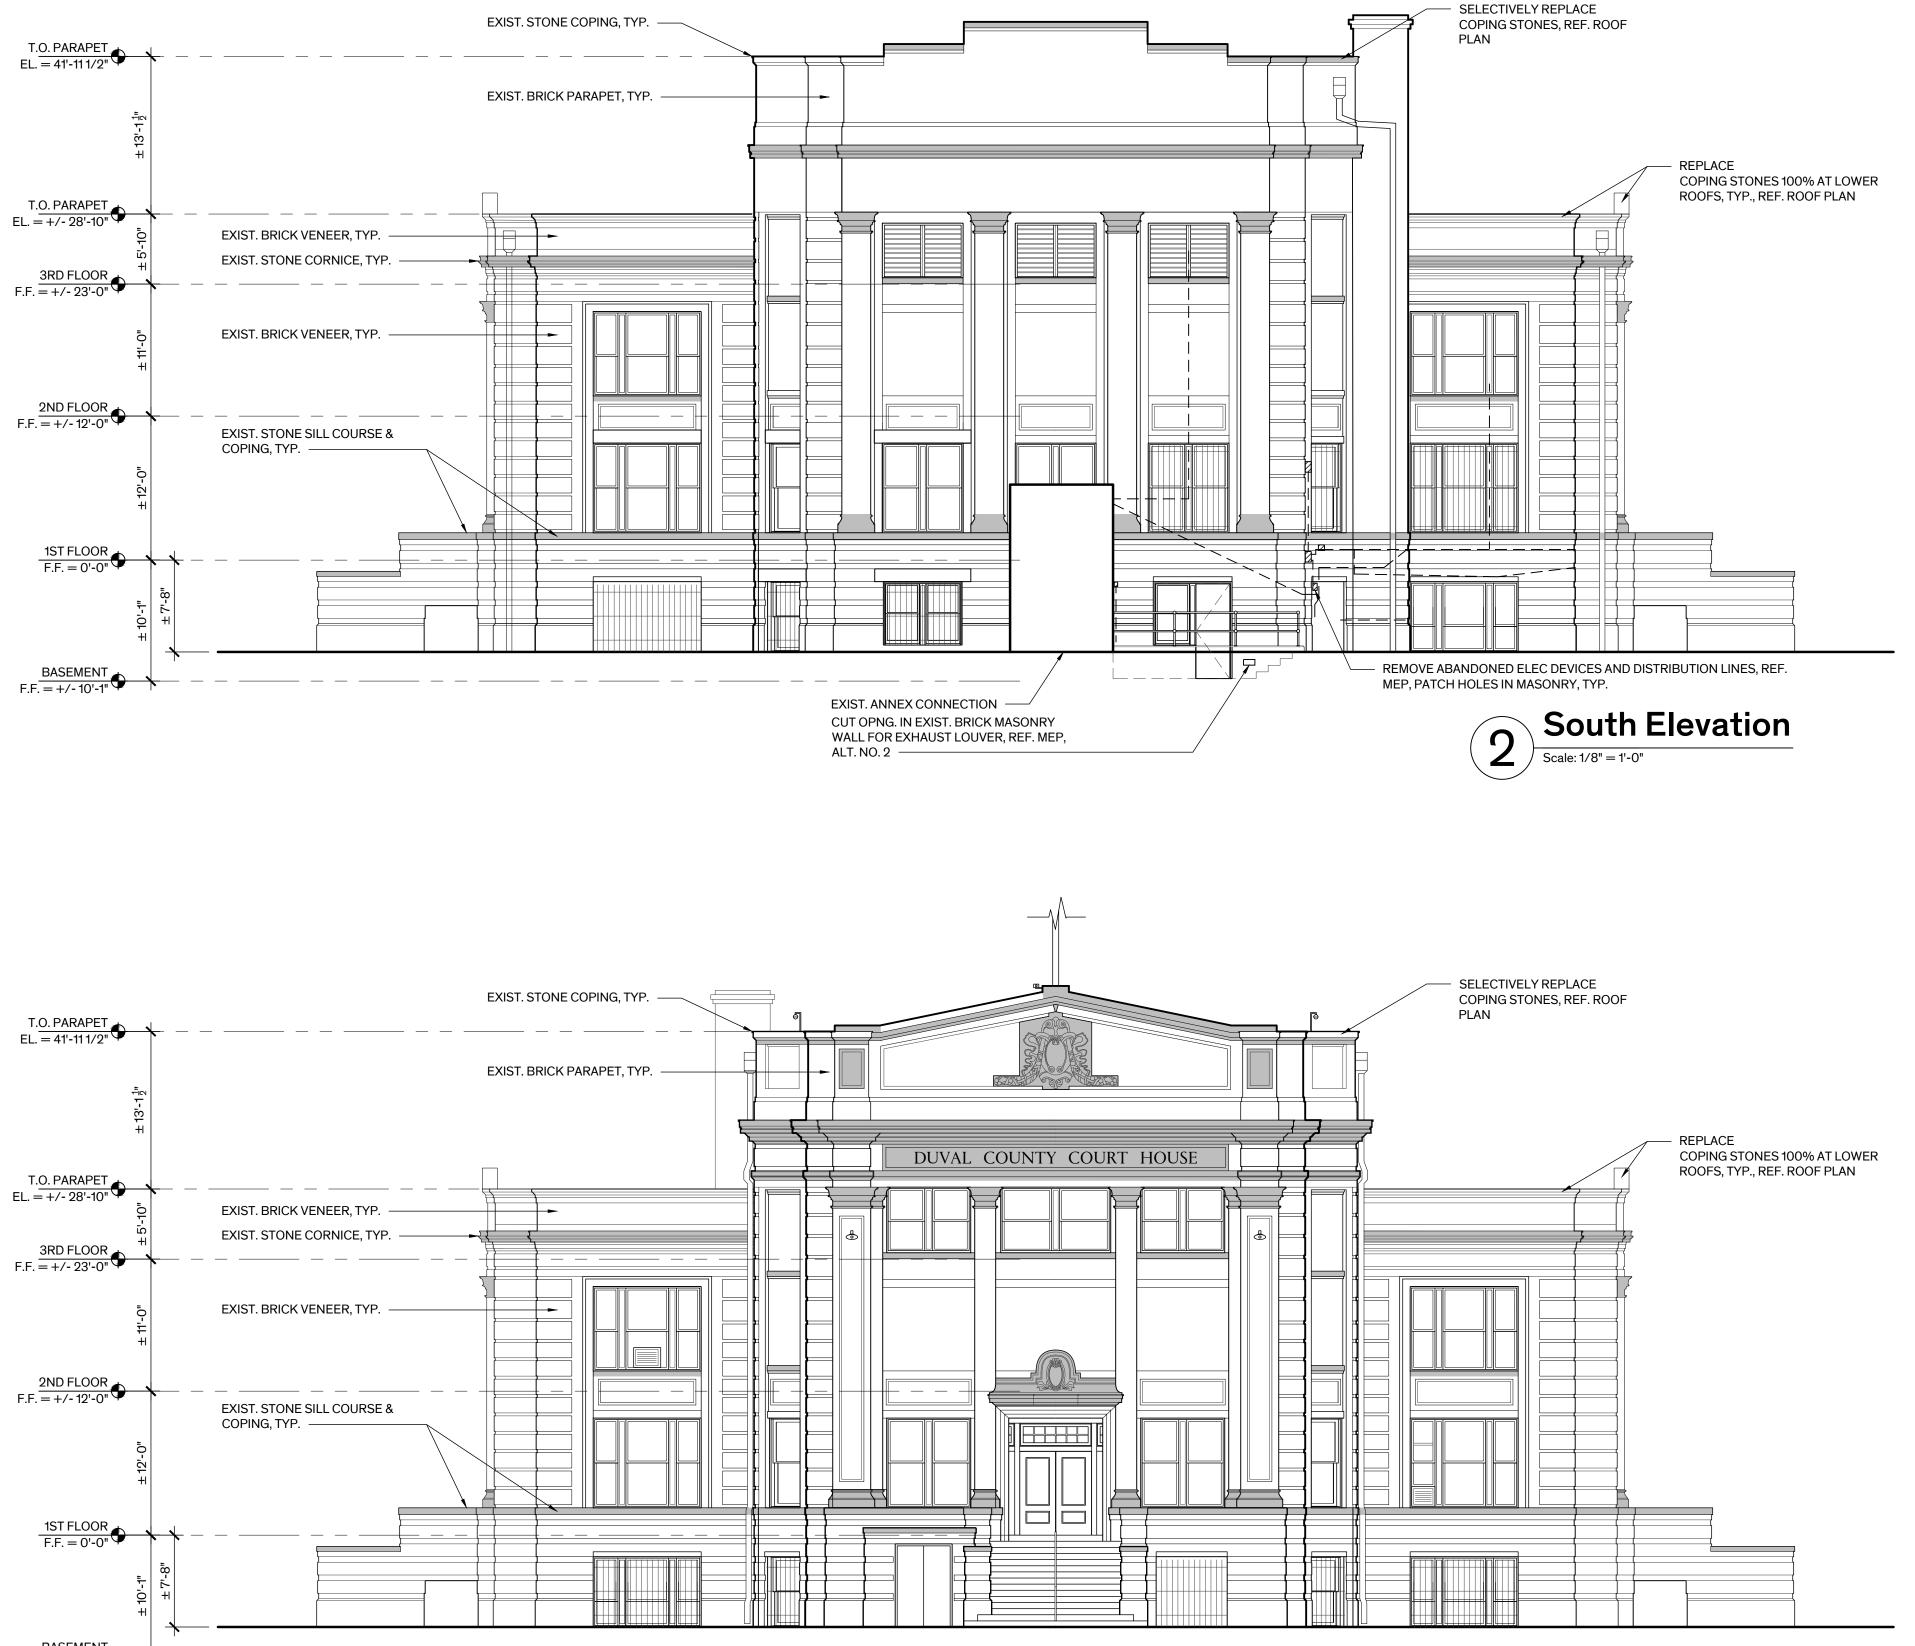





# **GENERAL NOTES - EXT. ELEV.**

- 1. EXTERIOR WINDOWS & WINDOW GRILLES: RESTORE WOOD WINDOW ASSEMBLIES AT THE BASEMENT LEVEL U.O.N. REMOVE & REINSTALL GRILLES AS REQUIRED TO ACCESS WINDOW TO COMPLETE WORK. REFER TO WINDOW SCHEDULE & GENERAL NOTES ON SHEET A-5.10 FOR SCOPE OF WORK.
- 2. DOORS: REFER TO DOOR SCHED. ON SHT. A-5.01 FOR SCOPE OF WORK.
- 8. ROOF: REPLACE COPING STONES 100% AT EAST & WEST LOWER ROOFS & SELECTIVELY REPLACE AT MAIN ROOF WHERE INDICATED ON THE DRAWINGS. REFER TO ROOF PLAN, SHT. A-2.10 FOR SCOPE OF WORK.
- **SEALANT:** REPLACE SEALANT AT PERIMETER OF DOOR & WINDOW OPENINGS AT ASSEMBLIES SCHEDULED TO BE RESTORED, AT NEW PENETRATIONS, & ELSEWHERE WHERE INDICATED ON THE DRAWINGS.

### . PAINTING: A. WOOD WINDOW ASSEMBLIES WHERE RESTORED OR REPLACED.

- B. WOOD DOOR ASSEMBLIES WHERE RESTORED OR REPLACED. C. METAL WINDOW GRILLES, TOUCH-UP PAINTING AT THE BASEMENT
- LEVEL WHERE REMOVED & REINSTALLED. D. SHEET METAL COPING, WHERE EXPOSED TO VIEW
- 6. ELECTRICAL REHABILITATION: REF. ELECTRICAL DRAWINGS. AT REMOVED
- CONDUIT & DEVICES PROPERLY REPAIR/PATCH BRICK & STONE MASONRY AS SPECIFIED REF. SPEC. SECTION 04905-MASONRY RESTORATION.
- MEP:
- A. REMOVE & REINSTALL MEP DEVICES & ASSOCIATED DISTRIBUTION LINES, INCLUDING SECURITY, LIGHTNING PROTECTION, & IT, AS REQUIRED TO COMPLETE THE WORK OF THIS CONTRACT.
- B. REMOVE ABANDONED DEVICES & ASSOCIATED DISTRIBUTION LINES IN AREA OF WORK & ELSEWHERE WHERE INDICATED ON THE DRAWINGS, CAP ENDS U.O.N.
- C. AT REMOVED DEVICES/LINES, PROPERLY REPAIR/PATCH BRICK & STONE MASONRY AS SPECIFIED, REF. SPEC. SECT, 04905 - MASONRY RESTORATION.
- D. COORDINATE POTENTIAL POWER/SERVICE OUTAGES WITH OWNER, PROVIDE MINIMUM 48 HOURS NOTICE PRIOR TO OUTAGE.

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Date 6/19/2025

Sheet Name NORTH & SOUTH EXTERIOR ELEVATIONS

Sheet Number

A-3.01

### LEGEND

EXIST. STONE ELEMENTS MASONRY PATCH AT REMOVED ELEC DEVICES, REF. MEP

ABANDONED DISTRIBUTION LINES TO BE REMOVED, \_ \_ \_ \_ PATCH HOLES IN MASONRY, REF. MEP

### ALTERNATES

REFER TO SPEC. SECTION 01230 - ALTERNATES FOR DETAILED DESCRIPTION OF WORK

ALTERNATE NO. 1: PREP & PAINT EXTERIOR WOOD DOORS B02, B04, 101, & 103.

ALTERNATE NO. 3: REMOVE PAINT COATINGS FROM EXIST. EXTERIOR STONE ELEMENTS TO EXPOSE NATURAL STONE FINISH.





# **GENERAL NOTES - EXT. ELEV.**

- 1. EXTERIOR WINDOWS & WINDOW GRILLES: RESTORE WOOD WINDOW ASSEMBLIES AT THE BASEMENT LEVEL U.O.N. REMOVE & REINSTALL GRILLES AS REQUIRED TO ACCESS WINDOW TO COMPLETE WORK. REFER TO WINDOW SCHEDULE & GENERAL NOTES ON SHEET A-5.10 FOR SCOPE OF WORK.
- 2. DOORS: REFER TO DOOR SCHED. ON SHT. A-5.01 FOR SCOPE OF WORK.
- 8. ROOF: REPLACE COPING STONES 100% AT EAST & WEST LOWER ROOFS & SELECTIVELY REPLACE AT MAIN ROOF WHERE INDICATED ON THE DRAWINGS. REFER TO ROOF PLAN, SHT. A-2.10 FOR SCOPE OF WORK.
- **SEALANT:** REPLACE SEALANT AT PERIMETER OF DOOR & WINDOW OPENINGS AT ASSEMBLIES SCHEDULED TO BE RESTORED, AT NEW PENETRATIONS, & ELSEWHERE WHERE INDICATED ON THE DRAWINGS.

### . PAINTING: A. WOOD WINDOW ASSEMBLIES WHERE RESTORED OR REPLACED.

- B. WOOD DOOR ASSEMBLIES WHERE RESTORED OR REPLACED. C. METAL WINDOW GRILLES, TOUCH-UP PAINTING AT THE BASEMENT
- LEVEL WHERE REMOVED & REINSTALLED. D. SHEET METAL COPING, WHERE EXPOSED TO VIEW
- **ELECTRICAL REHABILITATION:** REF. ELECTRICAL DRAWINGS. AT REMOVED CONDUIT & DEVICES PROPERLY REPAIR/PATCH BRICK & STONE MASONRY AS SPECIFIED REF. SPEC. SECTION 04905-MASONRY RESTORATION.
- MEP:
- A. REMOVE & REINSTALL MEP DEVICES & ASSOCIATED DISTRIBUTION LINES, INCLUDING SECURITY, LIGHTNING PROTECTION, & IT, AS REQUIRED TO COMPLETE THE WORK OF THIS CONTRACT.
- B. REMOVE ABANDONED DEVICES & ASSOCIATED DISTRIBUTION LINES IN AREA OF WORK & ELSEWHERE WHERE INDICATED ON THE DRAWINGS, CAP ENDS U.O.N.
- C. AT REMOVED DEVICES/LINES, PROPERLY REPAIR/PATCH BRICK & STONE MASONRY AS SPECIFIED, REF. SPEC. SECT, 04905 - MASONRY RESTORATION.
- D. COORDINATE POTENTIAL POWER/SERVICE OUTAGES WITH OWNER, PROVIDE MINIMUM 48 HOURS NOTICE PRIOR TO OUTAGE.

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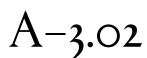
SEAL

Architexas No. 2433

Date 6/19/2025

Sheet Name EAST & WEST EXTERIOR ELEVATIONS

Sheet Number



LEGEND

\_ \_ \_ \_

EXIST. STONE ELEMENTS

MASONRY PATCH AT REMOVED ELEC DEVICES, REF. MEP


ABANDONED DISTRIBUTION LINES TO BE REMOVED, PATCH HOLES IN MASONRY, REF. MEP

### ALTERNATES

REFER TO SPEC. SECTION 01230 - ALTERNATES FOR DETAILED DESCRIPTION OF WORK

ALTERNATE NO. 1: PREP & PAINT EXTERIOR WOOD DOORS B02, B04, 101, & 103.

ALTERNATE NO. 3: REMOVE PAINT COATINGS FROM EXIST. EXTERIOR STONE ELEMENTS TO EXPOSE NATURAL STONE FINISH.

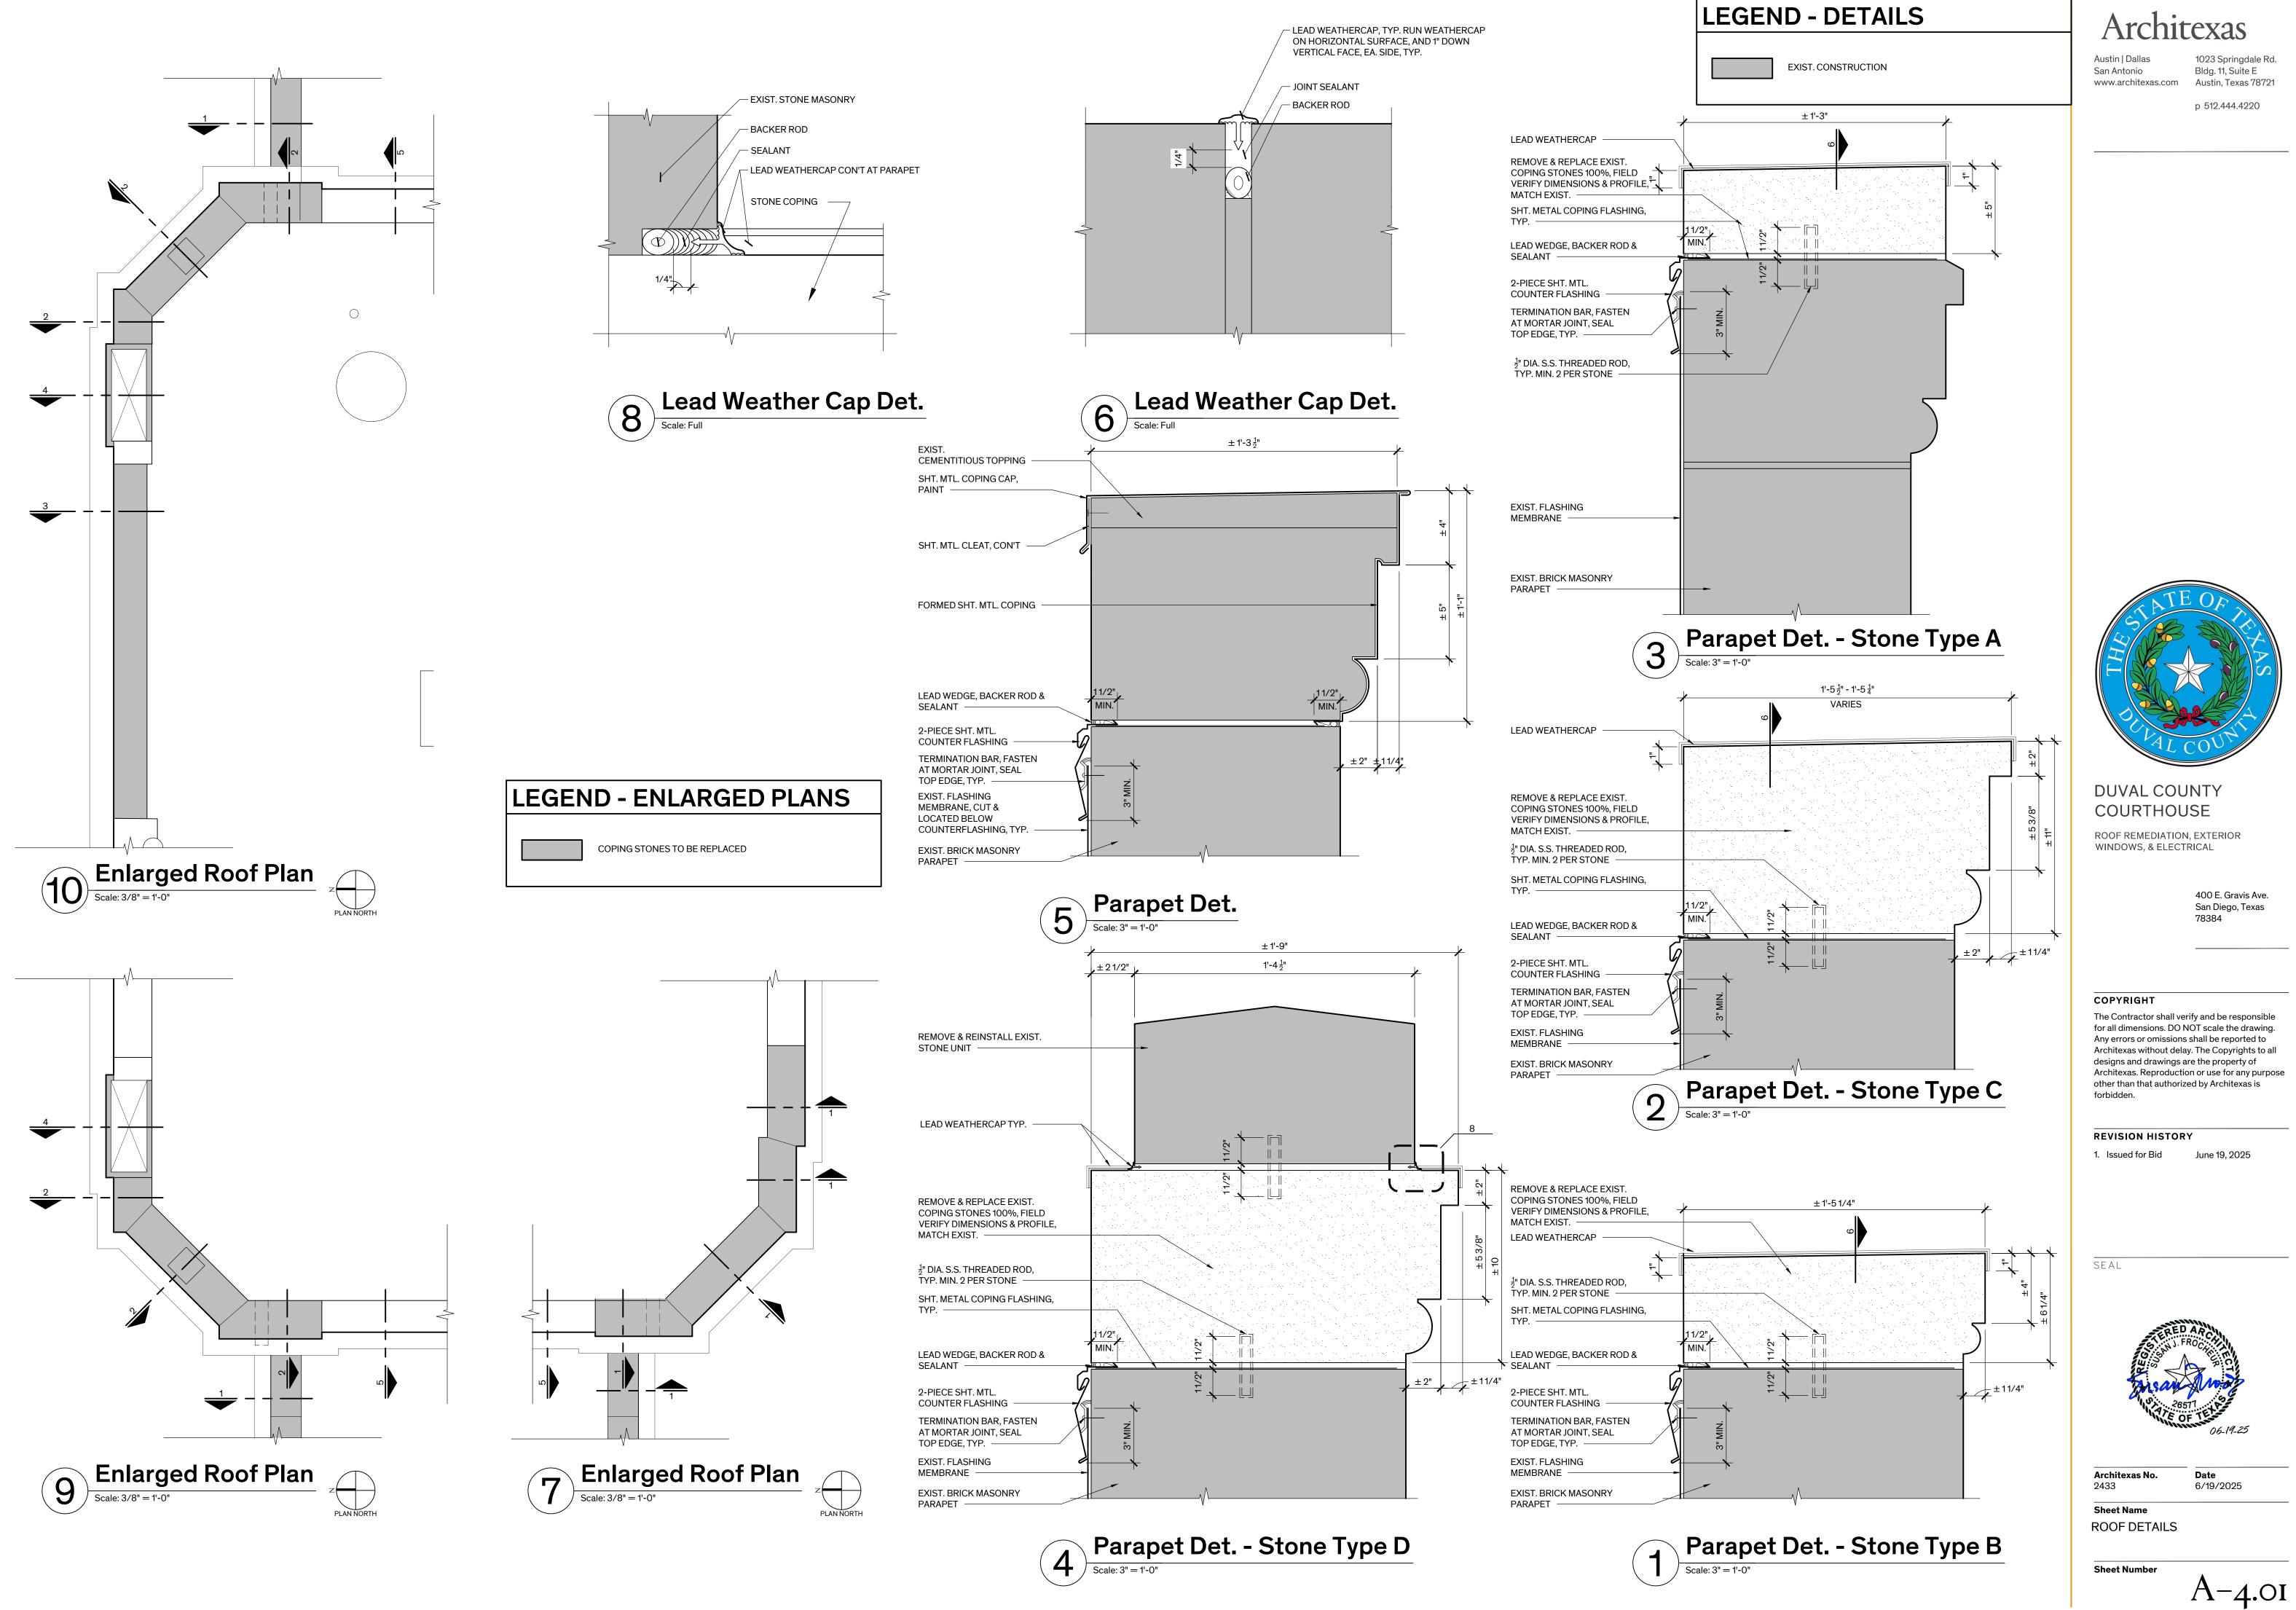



В	А	S	Е	Μ

	OOR #	, C
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	B03	
	B04	
		ост


DOOR # DOO NEW 102


### MENT LEVEL

000	RS	S CASINGS DOOR SIZE		CASINGS DOOR SIZE TYPE		YPE	MATERIAL		DETAILS				HARDWARE		DEMARKO
V	EXST.	NEW	EXST.	(V.I.F.)	DOOR	CASING	DOOR	FRAME	HEAD	JAMB	THRESH	TRANSOM	SET NO.	RATED	REMARKS
	•			3'-0" x 7'-0" x 1 3/4"	В	-	WOOD	НМ	-	-	6/A-5.01	-	В	-	FLIP DOOR SWING, RESTORE DOOR, ALT. NO. 2
		•		2'-10" X 7'-0" X 1 3/4"	A	-	HM	НМ	5/A-5.01	5/A-5.01	6/A-5.01	-	A	-	ALT. NO. 2


### FIRST FLOOR LEVEL

000	RS	CAS	INGS	DOOR SIZE	T	YPE	MATE	RIAL		DET	AILS		HARDWARE	RATED	REMARKS
V I	EXST.	NEW	EXST.	(V.I.F.)	DOOR	CASING	DOOR	FRAME	HEAD	JAMB	THRESH	TRANSOM	SET NO.	RAIED	REMARKS
				PAIR ±3'-0" x ±6'-11" x 2 1/4"	E1	-	Wood / Glass	Wood	-	-	-	-	E1	-	RECONSTRUCT DOORS

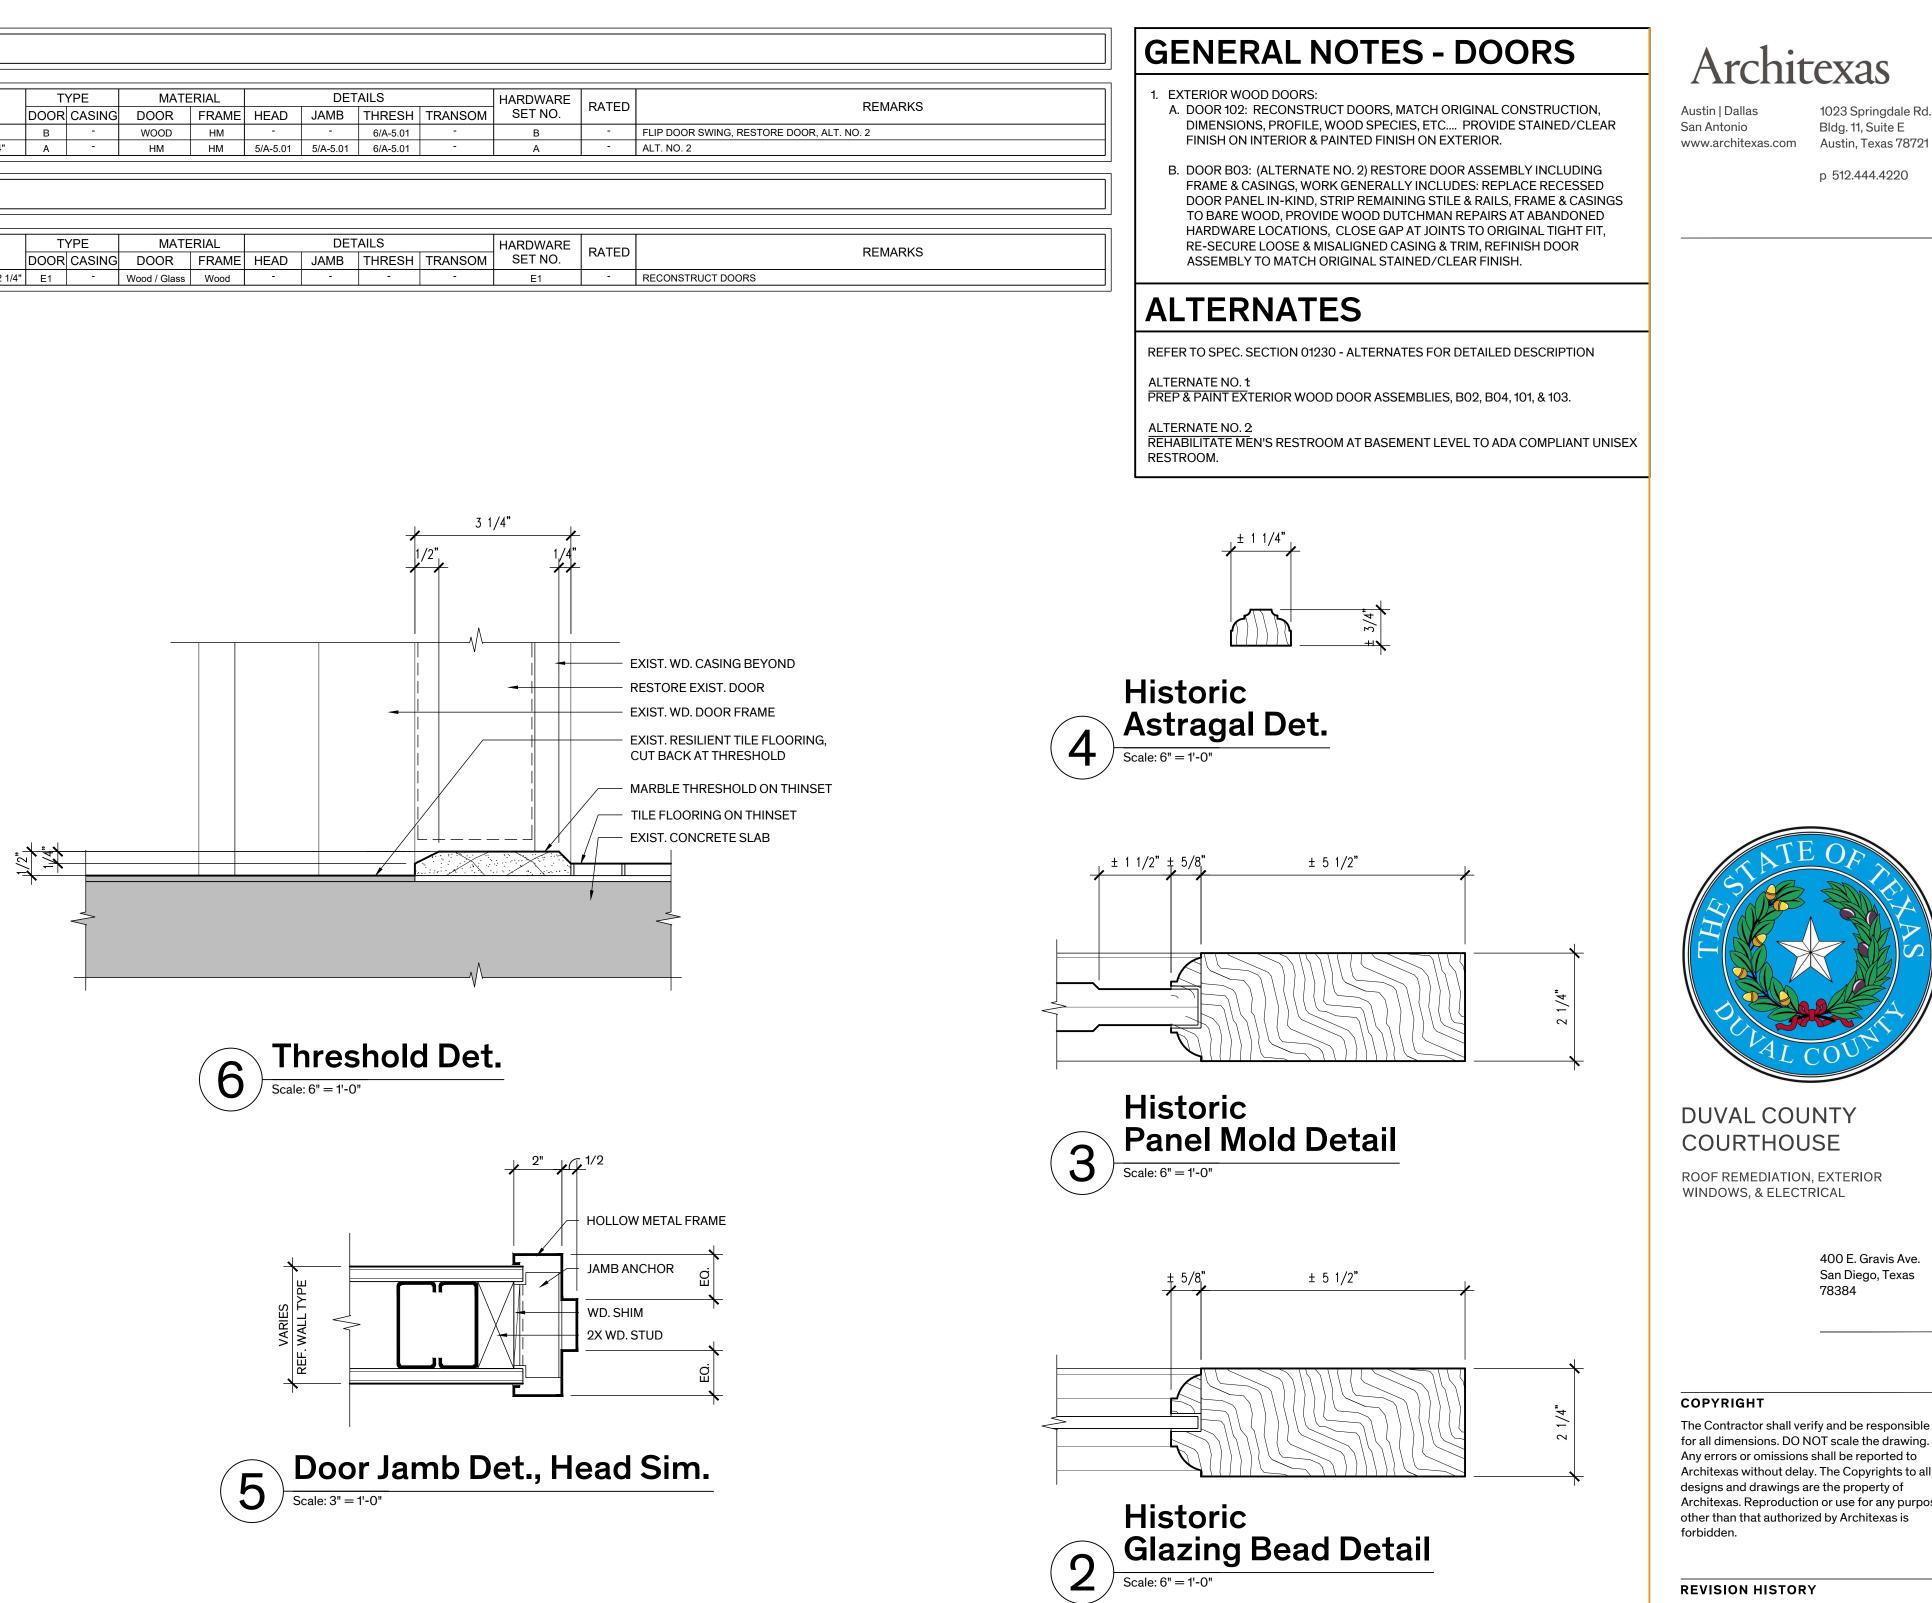

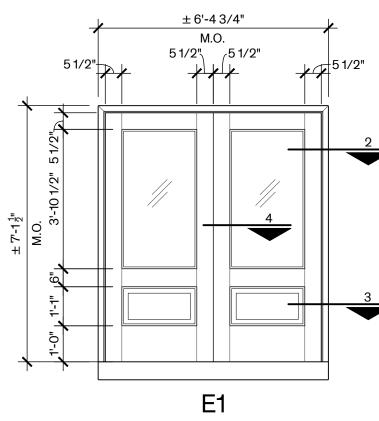

EXIST. HISTORIC OR RECONSTRUCTED WOOD DOOR W/WOOD & GLASS PANEL, BASEMENT & 1ST FLOOR

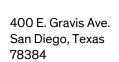

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SEAL

VARIES

Α

NEW HM DOOR & FRAME, BASEMENT

1 Door Types

JANITOR'S CLOSET

<u>↓</u> <u>₹</u>

В

EXIST. WD. DOOR,

RESTROOM





**Architexas No.** 2433

Date

6/19/2025

Sheet Name DOOR SCHEDULE, TYPES, NOTES, & DETAILS

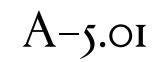


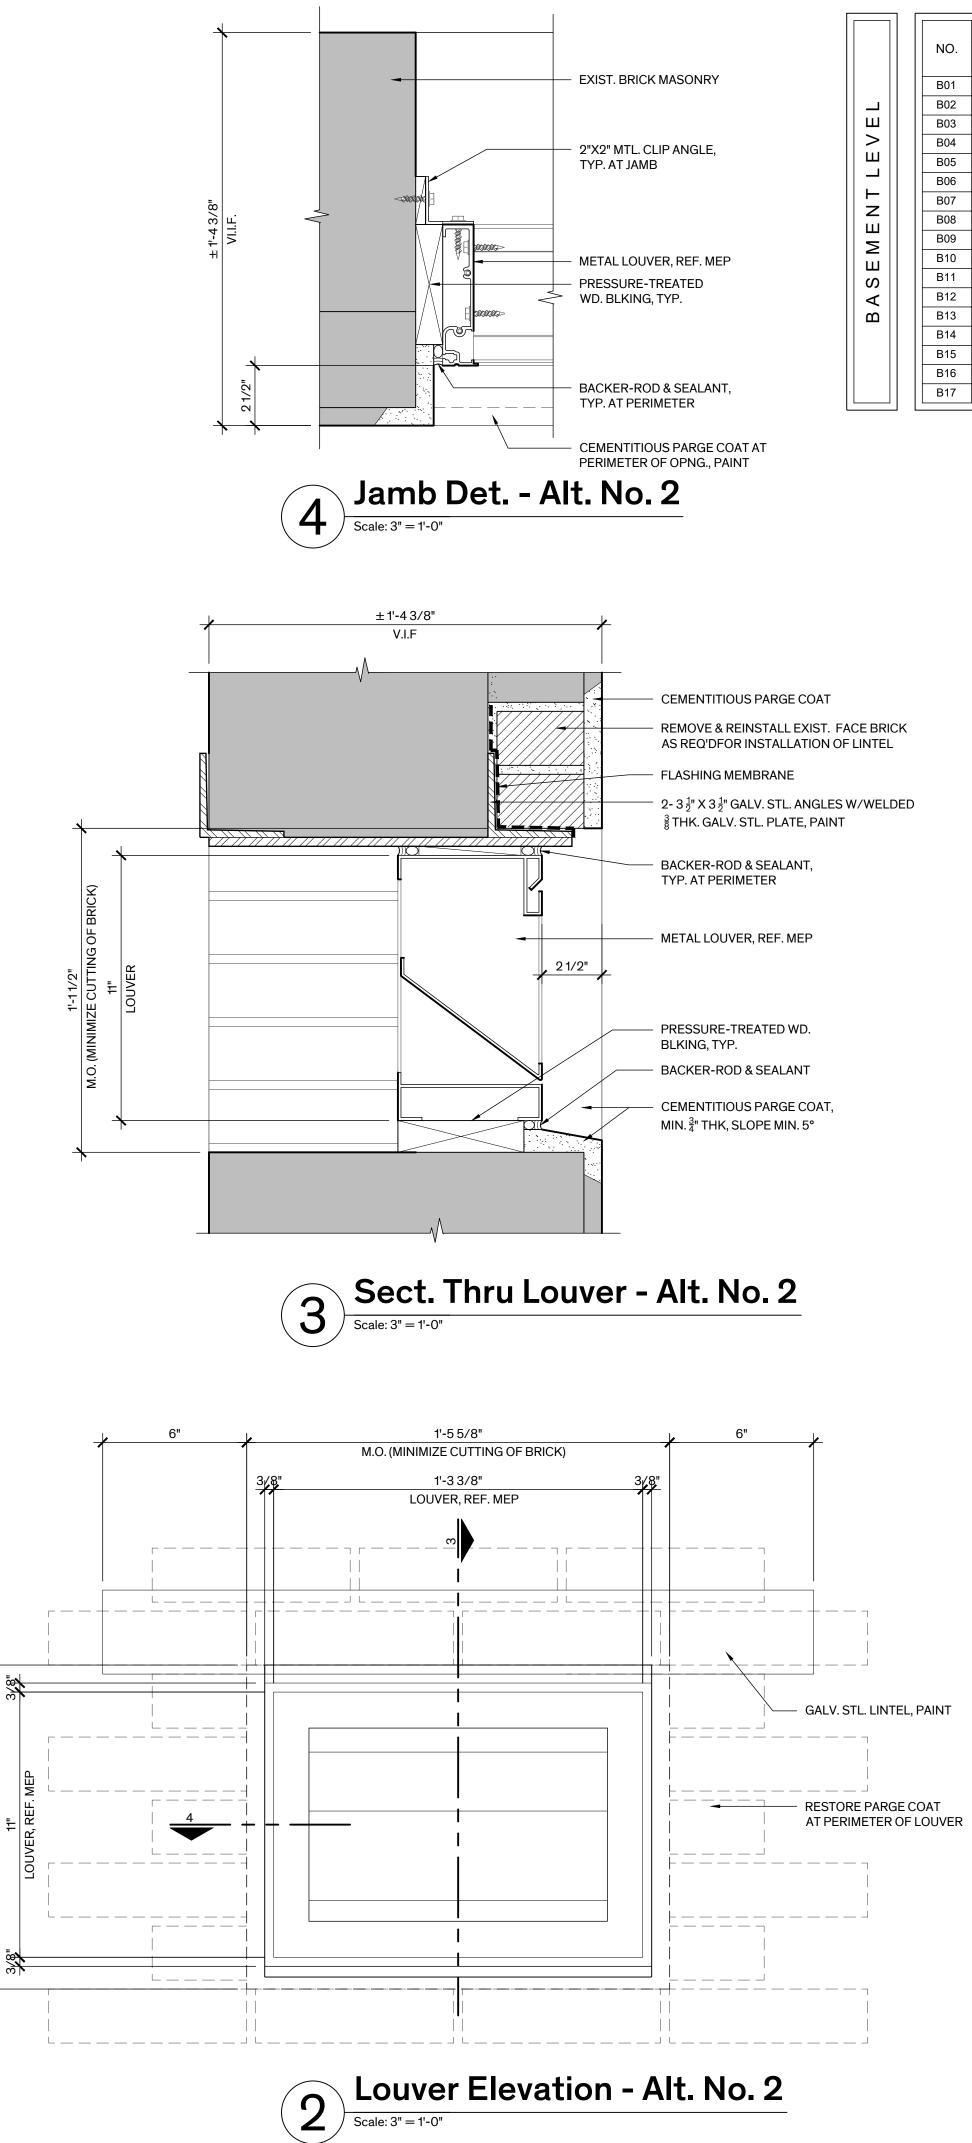

### WINDOW SCHEDULE

5514
REMA
Plywood Over Win
18-1938 Addition
Plywood Over Win
, Plywood Over W
, Plywood Over W
, Exist. Stone Lint
, Exist. Stone Lint
, Exist. Stone Lint

	CEMENTITIOUS PARGE COAT
	REMOVE & REINSTALL EXIST. FACE BRICK AS REQ'DFOR INSTALLATION OF LINTEL
	FLASHING MEMBRANE
	2- $3\frac{1}{2}$ " X $3\frac{1}{2}$ " GALV. STL. ANGLES W/WELDED $\frac{3}{8}$ THK. GALV. STL. PLATE, PAINT
	BACKER-ROD & SEALANT, TYP. AT PERIMETER
	METAL LOUVER, REF. MEP
_	

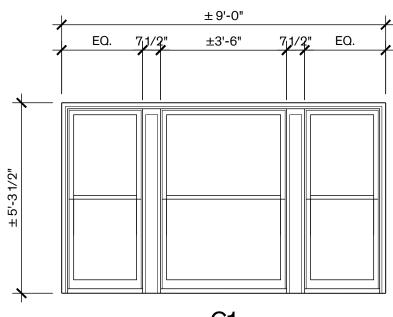

BASEMENT F.F. = - 10'-1"

1'-11/2" IMIZE CUTTING OF

<u>М</u>.О

IARKS	
Vindow	
on per M.P.	
Vindow; Int. Blocked Up	
r Window	
r Window	
intel	
intel	
intel; Opng. Blocked Up W/Brick	
	-

# **GENERAL NOTES**

EXIST. WINDOWS & WINDOW GRILLES:

- A. RESTORE WOOD WINDOW ASSEMBLIES AT THE BASEMENT LEVEL U.O.N. WORK GENERALLY INCLUDES: REPLACEMENT OF SASHES, GLASS, PARTING STRIP, & EXTERIOR MULLION TRIM; RESTORATION OF FRAME, BLIND STOP, SILL, BRICK MOLD & INTERIOR STOPS; NO WORK TO INTERIOR JAMB & HEAD EXTENSIONS, CASINGS, STOOL, APRON, & TRIM. REPLACEMENT OF MISSING OR DETERIORATED ELEMENTS BEYOND REPAIR SHALL BE REPLACED UNDER ALLOWANCES AS DETERMINED BY UNIT PRICES, REFER TO SPEC. SECTS. 01210 & 01226.
- B. HARDWARE: REPLACE SASH LOCKS, PULLS & LIFTS WHERE MISSING OR DETERIORATED BEYOND REPAIR; REPLACE SASH CHAINS 100%; PROVIDE ADDITIONAL SASH WEIGHTS TO ACCOMMODATE THICKER GLASS; REINFORCE LOWER RAIL OF UPPER SASH FOR HEAVIER GLASS; FIX UPPER SASHES WITH STAINLESS STEEL ANGLES EMBEDDED IN UPPER SASH & FRAME PER DET. 8/A-5.11 PROVIDE WEATHERSTRIPPING PER DETS. 6, 7, 8, & 9/A-5.11.
- C. WINDOW TREATMENT: REMOVE WINDOW TREATMENT ENTIRELY INCLUDING BRACKETS & FASTENERS.
- D. REMOVE & REINSTALL GRILLES AS REQUIRED TO ACCESS WINDOW TO COMPLETE WORK. TOUCH-UP PAINT.
- 2. TEMPORARY PROTECTION: PROVIDE TEMPORARY ENCLOSURES FOR WINDOW OPENINGS AS REQUIRED FOR SECURITY & TO ENSURE BUILDING IS WEATHERTIGHT.
- 3. SEALANTS: A. REMOVE & REPLACE PERIMETER SEALANT 100%. B. AT FIXED SASHES, SEAL PERIMETER OF SASH.
- . WINDOW FINISH: AT WINDOWS SCHEDULED FOR RESTORATION, PAINT EXTERIOR SURFACE, ASSUME TWO COLOR SCHEME, SASHES ONE COLOR & FRAME, BRICK MOLD & SILL A SECOND COLOR. STAIN INTERIOR SURFACES OF REPLACEMENT ELEMENTS TO MATCH ORIGINAL FINISH.

### LEGEND

EXIST. CONSTRUCTION

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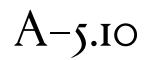



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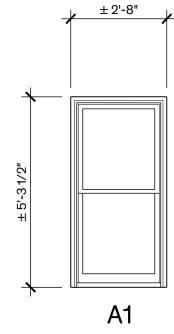
Date 6/19/2025

Sheet Name WINDOW SCHEDULE, TYPES, & NOTES

Sheet Number







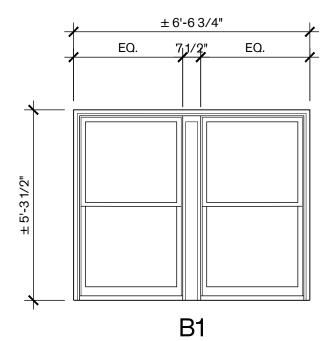

Window Types

) Scale: 1/4" = 1'-0"

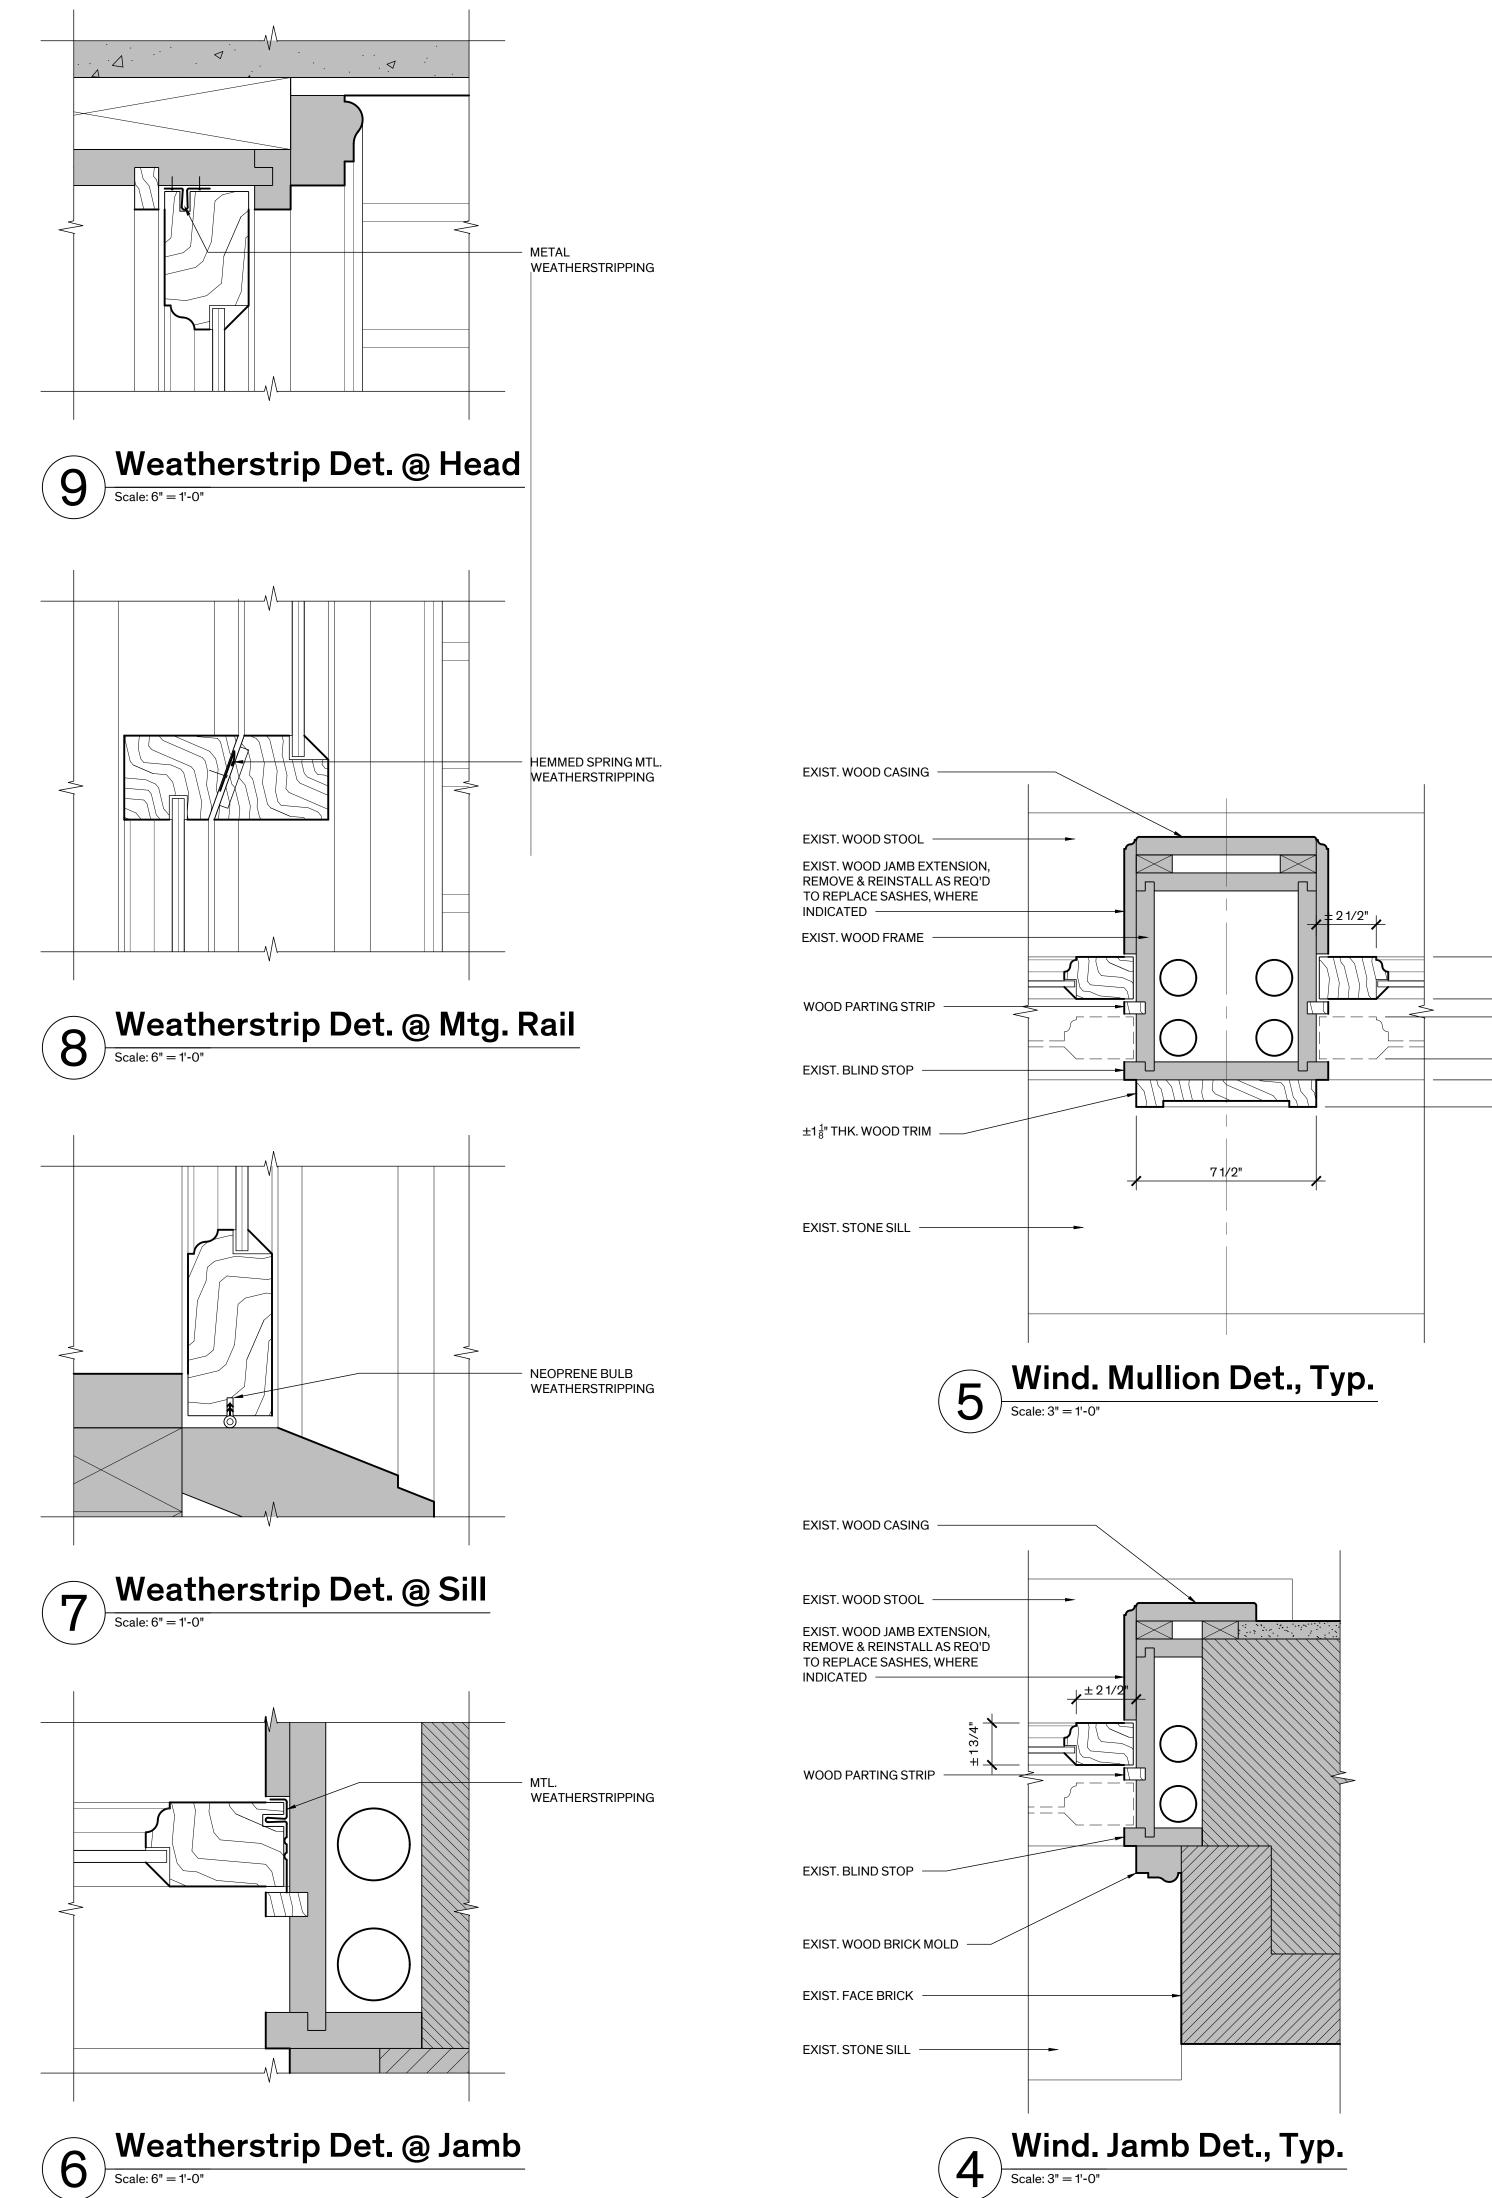

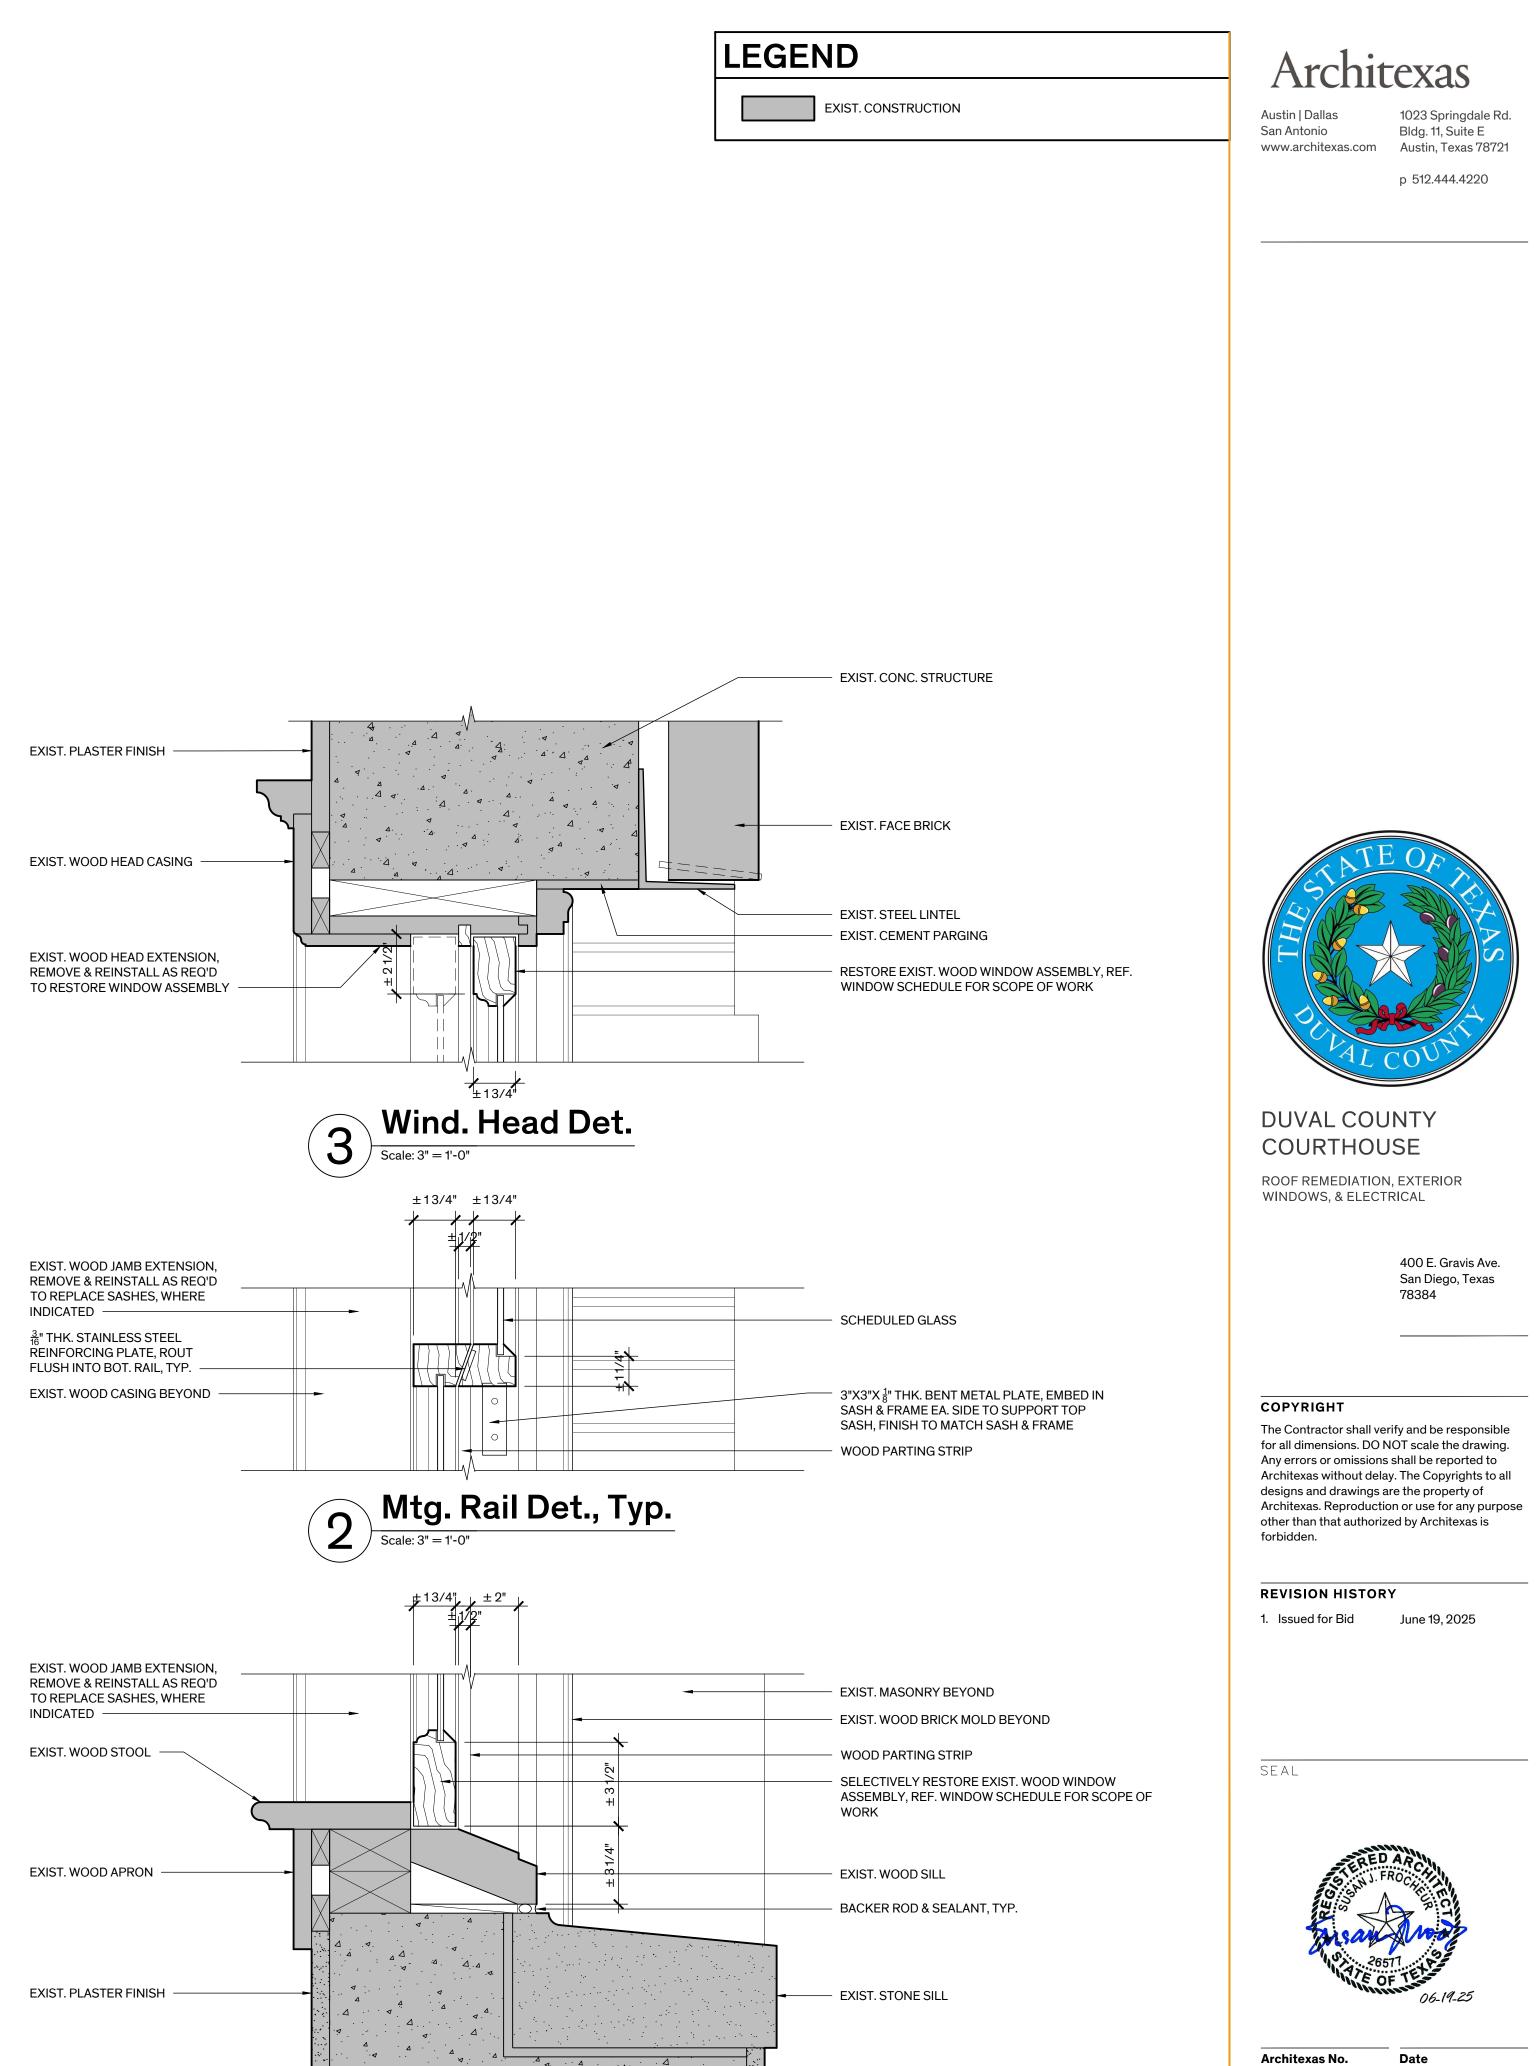

**1** Wind. Sill Det., Typ. Scale: 3" = 1'-0"

EXIST. CEMENT PARGING ON CONC. STRUCTURE


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Sheet Number

WINDOW DETAILS


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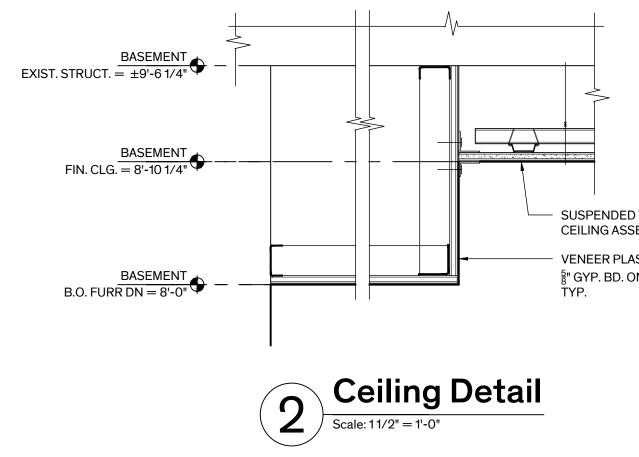


6/19/2025

RM #	RO
B03	ADA U RESTF
B04	JANIT

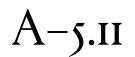



	ROOM FINISH SCHEDULE - BASEMENT FLOOR LEVEL											
	FLOOR	BASE	WAINSCOT		WA		CEILING					
OM NAME		K DASE	VVAINSCUT	NORTH	SOUTH	EAST	WEST	CEILING				
UNISEX TROOM	TILE	TILE	TILE	EXIST. PLASTER/ VENEER PLASTER			EXIST. PLASTER/ VENEER PLASTER	SUSPENDED VENEER PLASTER	ALT. NO. 2			
TORS CLOSET	EXIST. CONC.	-	-	GYP. BD.	GYP. BD./ EXIST. GYP. BD.	EXIST. BRICK/ EXIST. TERRA COTTA	EXIST. PLASTER	EXIST. STRUCT.	ALT. NO. 2			

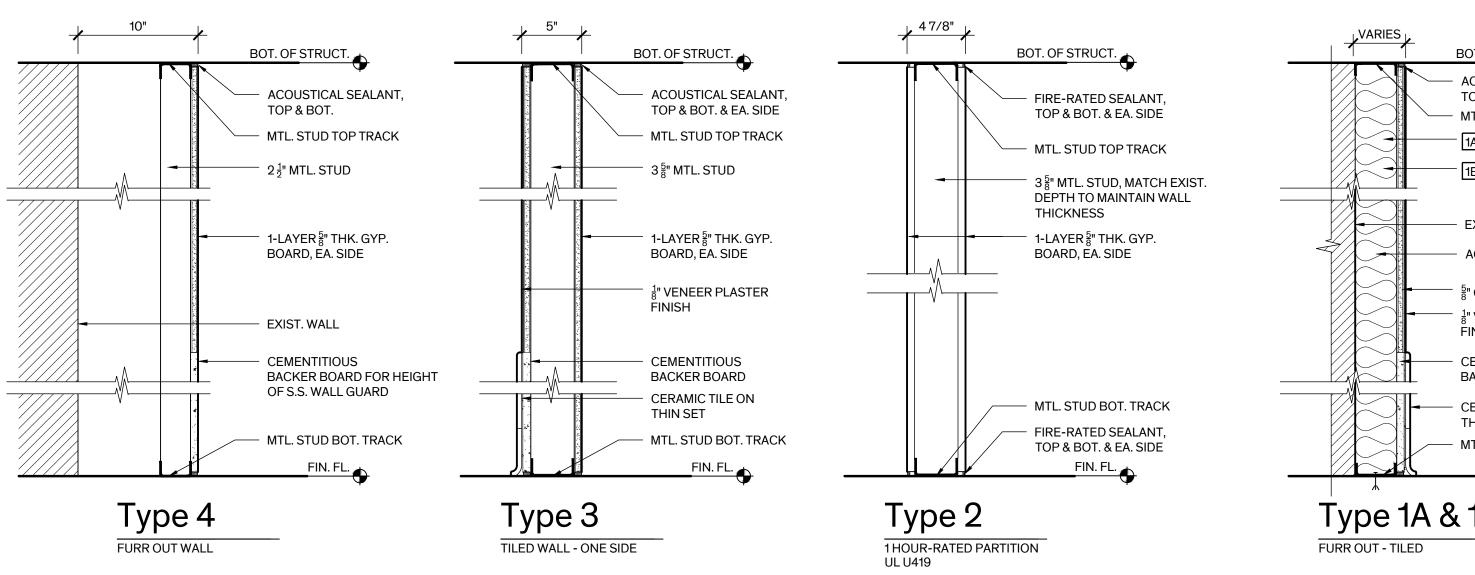




	GENERAL FINISH NOTES	Architexas
REMARKS	1. DEMOLITION: REFER TO DEMO PLANS FOR AREAS OF FINISH REMOVAL. PREPARE EXIST. SUBSTRATE SCHEDULED TO REMAIN AS NECESSARY TO PROVIDE A SOUND SUBSTRATE FOR PROPER INSTALLATION OF SCHEDULED FINISHES.	Austin   Dallas1023 Springdale Rd.San AntonioBldg. 11, Suite E
2	2. FINISHING AT CONCEALED LOCATIONS: REMOVE LOOSE, DELAMINATING, & DAMAGED FINISHES AT NEW SUSPENDED CEILINGS, FURR DOWNS, MECHANICAL CHASES, ETC DO NOT REPAIR OR PAINT FINISH SURFACES	www.architexas.com Austin, Texas 78721 p 512.444.4220
2	AT CONCEALED LOCATIONS.  3. SURFACES: FINISH EXPOSED SURFACES IN AREA OF WORK & WHERE	
	AFFECTED BY THE WORK OF THE CONTRACT U.O.N. 4. RESTORE EXIST. FLOOR FINISH: A. EXIST. CONCRETE & SCORED CONCRETE:	
	<ul> <li>(1) REMOVE LOOSE &amp; DAMAGED CONCRETE TO SOUND SUBSTRATE.</li> <li>(2) CLEAN CONCRETE 100% WHERE SCHEDULED TO REMAIN EXPOSED</li> <li>(3) REPAIR HOLES, INDENTATIONS, &amp; CRACKS; HAIRLINE CRACKS LESS THAN <sup>1</sup>/<sub>16</sub>" WIDE DO NOT REQUIRE REPAIR.</li> <li>(4) APPLY CLEAR SEALER.</li> </ul>	
	<ul> <li>4. WALLS:</li> <li>A. EXIST. PLASTER: REMOVE DAMAGED &amp;/OR DETERIORATED &amp; DELAMINATING PLASTER FINISH TO SOUND SUBSTRATE, RE-POINT/RESET MASONRY AS NECESSARY TO PROVIDE A SOUND SUBSTRATE &amp; PROPER KEY FOR NEW PLASTER. REPLACE MISSING OR DAMAGED METAL LATH, REPLACE DAMAGED, DETERIORATED &amp; DELAMINATING, POORLY PATCHED, MISSING OR NON-MATCHING PLASTER FINISH. REPAIR CRACKS, HOLES, DEEP GOUGES &amp; INDENTATIONS. PROVIDE A SEAMLESS TRANSITION BETWEEN NEW &amp; EXIST. PLASTER, FINISH AS REQUIRED TO MATCH TEXTURE OF ORIGINAL SURFACE. WITHIN A SPACE ASSUME ONE COLOR FOR FLAT PLASTER WALLS &amp; A SECOND COLOR FOR PLASTER CEILING.</li> <li>B. EXIST. BRICK: RE-POINT MISSING &amp; DETERIORATED MORTAR JOINTS.</li> <li>C. EXIST. TERRA COTTA: RE-POINT MISSING &amp; DETERIORATED MORTAR JOINTS.</li> </ul>	
	<ul> <li>5. CEILING:</li> <li>A. EXIST. STRUCTURE: REMOVE DAMAGED, DETERIORATED, OR DELAMINATING CONCRETE STRUCTURE TO SOLID SUBSTRATE.</li> </ul>	
	<ul> <li>6. DOOR ASSEMBLIES:</li> <li>A. EXTERIOR STILE &amp; RAIL WOOD DOOR ASSEMBLIES SHALL HAVE A PAINTED FINISH ON EXTERIOR EXPOSED SURFACES &amp; A STAINED/CLEAR FINISH ON EXPOSED INTERIOR SURFACES TO MATCH ORIGINAL FINISH.</li> <li>B. INTERIOR STILE &amp; RAIL WOOD DOOR ASSEMBLIES SHALL HAVE A STAINED/CLEAR FINISH TO MATCH ORIGINAL FINISH.</li> <li>C. INTERIOR HOLLOW METAL DOOR ASSEMBLIES SHALL HAVE A PAINTED FINISH.</li> </ul>	
	7. WINDOW ASSEMBLIES: REFER TO SHT. A-5.10 FOR FINISHING EXTERIOR WINDOWS SCHEDULED FOR RESTORATION.	ATE OF
	8. EXPOSED MEP COMPONENTS: NEW EXPOSED DUCTS, CONDUIT, PIPING, WIRING, ASSOCIATED FASTENERS, ETC ARE TO BE PRIMED & PAINTED EXCEPT IN MECHANICAL & ELECTRICAL ROOMS, JANITOR'S CLOSET & ATTIC.	
VENEER PLASTER EMBLY		DUVAL COUNTY COURTHOUSE
STER FURR DOWN, N 2 <u>1</u> " MTL. STUD,		ROOF REMEDIATION, EXTERIOR WINDOWS, & ELECTRICAL
		400 E. Gravis Ave. San Diego, Texas 78384
		<b>COPYRIGHT</b> The Contractor shall verify and be responsible for all dimensions. DO NOT scale the drawing. Any errors or omissions shall be reported to Architexas without delay. The Copyrights to all designs and drawings are the property of Architexas. Reproduction or use for any purpose other than that authorized by Architexas is forbidden.
T. OF STRUCT. COUSTICAL SEALANT, OP & BOT. & EA. SIDE CL. STUD TOP TRACK		<b>REVISION HISTORY</b> 1. Issued for Bid June 19, 2025
3]- 2 <sup>1</sup> / <sub>2</sub> " MTL. STUD		
KIST. WALL		SEAL
GYP. BOARD /ENEER PLASTER IISH MENTITIOUS CKER BOARD		S SN J. FROC
RAMIC TILE ON IIN SET 'L. STUD BOT. TRACK	ALTERNATES	06-19-25
- FIN. FL.	REFER TO SPEC. SECTION 01230 - ALTERNATES FOR DETAILED DESCRIPTION ALTERNATE NO. 1: PREP & PAINT EXTERIOR WOOD DOORS B02, B04, 101, &	Architexas No.         Date           2433         6/19/2025
	103. ALTERNATE NO. 2 REHABILITATE MEN'S RESTROOM AT BASEMENT LEVEL TO ADA COMPLIANT UNISEX RESTROOM.	Sheet Name FINISH SCHEDULE, WALL TYPES, & CEILING DETAILS
I Types	ALTERNATE NO. 4: PROVIDE GYPSUM BOARD WALL & CEILING FINISH IN REHABILITATED UNISEX RESTROOM B03 IN LIEU OF VENEER PLASTER.	Sheet Number
∠ — I-U		A-6.01

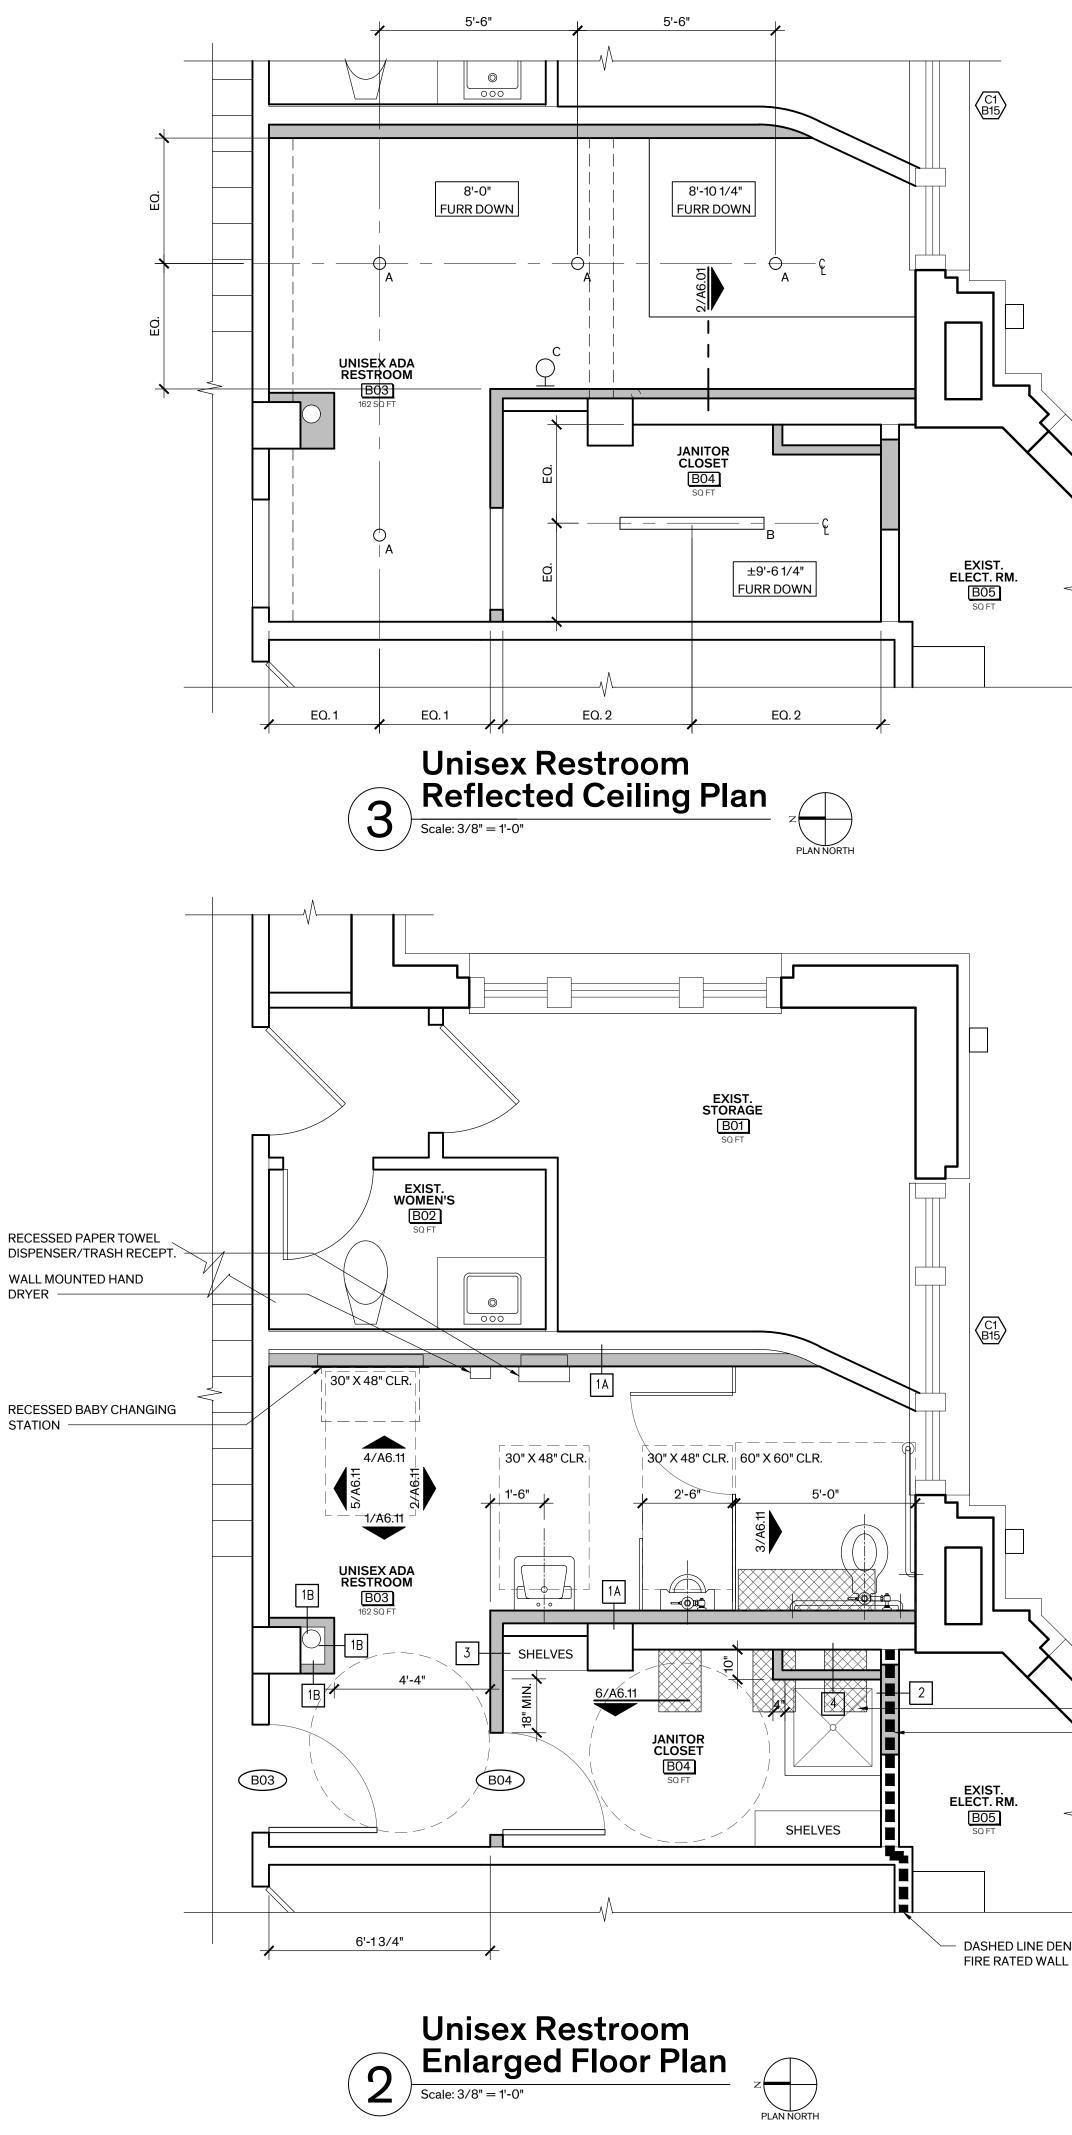

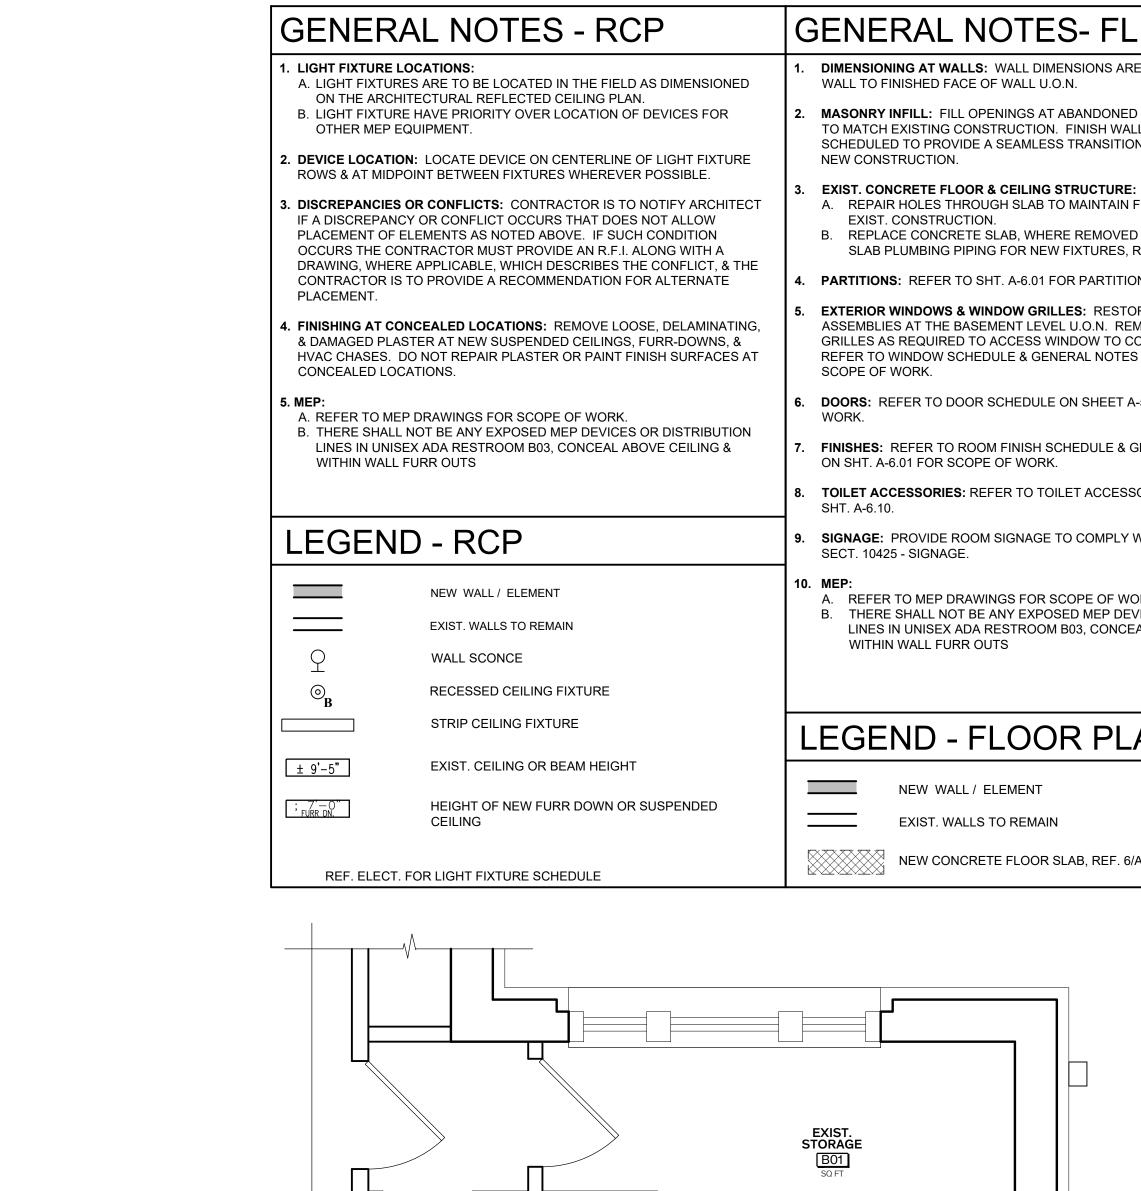

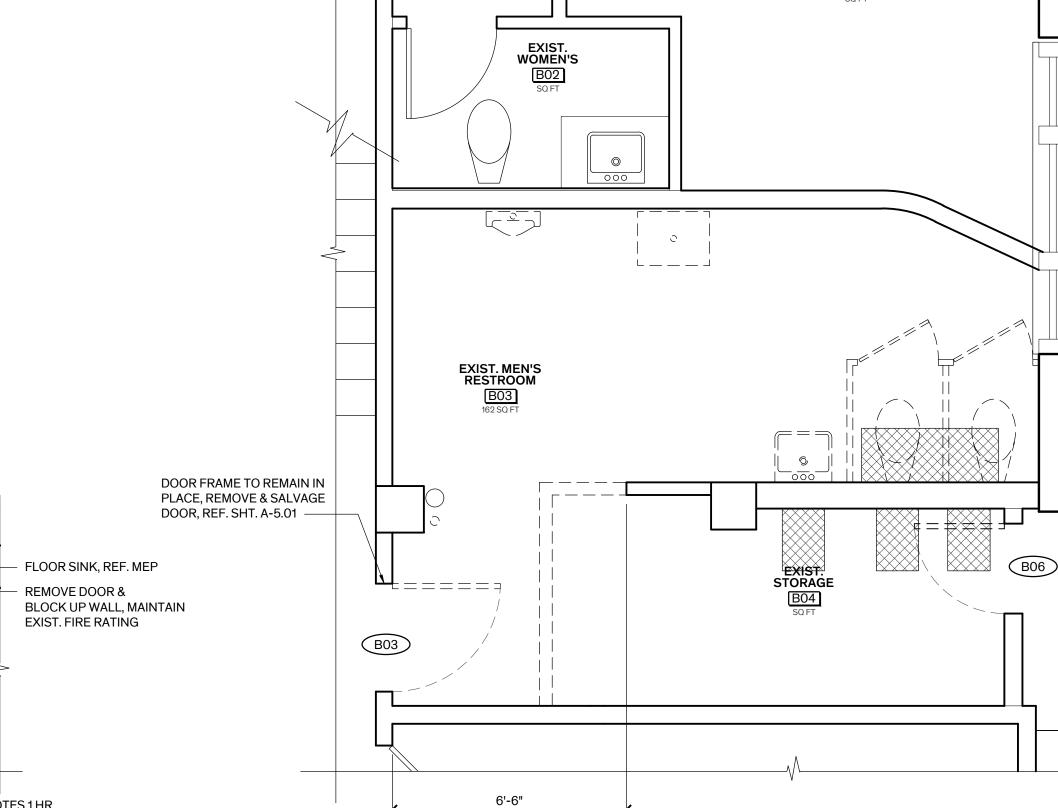

DASHED LINE DENOTES 1 HR





C1 B15

EXIST. ELECT. RM.

B05 SQ FT

FL. PLAN	GENERAL NOTES-DEMO PLAN	Architexas
ONS ARE FINISHED FACE OF	1. GENERAL: ITEMS NOT MARKED FOR REUSE ARE TO BE SALVAGED FOR THE OWNER OR ARE TO BE REMOVED FROM THE SITE & PROPERLY DISPOSED OF PER LOCAL CODE. COORDINATE ITEMS TO BE SALVAGED WITH OWNER.	Austin   Dallas 1023 Springdale Rd.
IDONED MEP PENETRATIONS SH WALLS & CEILINGS AS ANSITION BETWEEN EXIST. &	<ul> <li>2. PROTECTION:</li> <li>A. PRIOR TO THE START OF SELECTIVE DEMOLITION &amp; ABATEMENT WORK PROTECT INTERIOR FINISHES &amp; ELEMENTS SCHEDULED TO</li> </ul>	San Antonio Bldg. 11, Suite E www.architexas.com Austin, Texas 78721 p 512.444.4220
<b>CTURE:</b> INTAIN FIRE RATING, MATCH	REMAIN DURING DEMOLITION & CONSTRUCTION PROCEDURES. DAMAGE TO EXISTING FINISH SURFACES AND ELEMENTS BY THE CONTRACTOR SHALL BE CORRECTED AT NO ADDITIONAL EXPENSE TO THE OWNER.	
EMOVED TO MODIFY BELOW TURES, REF. MEP	<ul> <li>B. REMOVE DEBRIS FROM DEMOLITION AT THE END OF EACH WORK DAY, &amp; MAINTAIN BUILDING IN A SAFE MANNER CLEAR OF DEMOLITION &amp; CONSTRUCTION DEBRIS AND EQUIPMENT.</li> </ul>	
ARTITION TYPES. RESTORE WOOD WINDOW D.N. REMOVE & REINSTALL	<b>3. FLOORS:</b> REMOVE CONCRETE FLOOR AS REQUIRED TO MODIFY BELOW SLAB PLUMBING PIPING FOR NEW FIXTURES, REF. MEP.	
W TO COMPLETE WORK. . NOTES ON SHEET A-5.10 FOR	<ol> <li>WALLS: REMOVE &amp; DISCARD WALLS &amp; ASSOCIATED FASTENERS WHERE INDICATED ON THE DRAWINGS.</li> </ol>	
HEET A-5.01 FOR SCOPE OF	5. DOORS: A. DOOR B06: REMOVE EXIST. DOOR ASSEMBLY ENTIRELY, SALVAGE HARDWARE TO OWNER.	
ULE & GENERAL FINISH NOTES	B. DOOR BO3: REMOVE EXIST. DOOR & SALVAGE FOR REUSE, REFER TO SHT. A-5.01 FOR SCOPE OF WORK.	
ACCESSORY SCHEDULE ON	<ol> <li>MEP: REMOVE EXIST. PLUMBING &amp; ELECTRICAL LINES AS INDICATED ON MEP DRAWINGS.</li> </ol>	
OMPLY WITH TAS, REF. SPEC.	<ol> <li>RESTROOMS: REMOVE EXISTING FIXTURES, STALL PARTITIONS, &amp; TOILET ACCESSORIES ENTIRELY.</li> </ol>	
E OF WORK. IEP DEVICES OR DISTRIBUTION	8. HAZARDOUS MATERIALS ABATEMENT: REFER TO ASBESTOS ABATEMENT PROJECT DESIGN & LEAD PAINT REMOVAL WORK PLAN FOR SCOPE OF WORK.	
CONCEAL ABOVE CEILING &	LEGEND - DEMO PLAN	
	ELEMENT TO BE REMOVED	
PLAN	EXIST. WALLS TO REMAIN	
	DOOR TO BE REMOVED	
	WALLS TO BE REMOVED	TEOP
REF. 6/A6.11	CONCRETE FLOOR SLAB TO BE REMOVED	

CUT OPNG. IN EXIST. BRICK MASONRY WALL FOR EXHAUST LOUVER. LOCATE LOUVER BELOW ELEVATION OF AREAWAY WALL, REF. MEP DWGS. COORD. EXACT LOCATION W/ ARCHITECT

# ALTERNATES

REFER TO SPEC. SECTION 01230 - ALTERNATES FOR DETAILED DESCRIPTION

ALTERNATE NO. 2: REHABILITATE MEN'S RESTROOM AT BASEMENT LEVEL TO ADA COMPLIANT UNISEX RESTROOM

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### COPYRIGHT

DUVAL COUNTY

WINDOWS, & ELECTRICAL

ROOF REMEDIATION. EXTERIOR

COURTHOUSE

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**REVISION HISTORY** 

1. Issued for Bid

June 19, 2025


SEAL




Architexas No. 2433

Date 6/19/2025

Sheet Name ENLARGED DEMO PLAN, FLOOR PLAN & REFLECTED CEILING PLAN

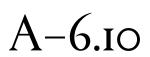


ROOM # B03

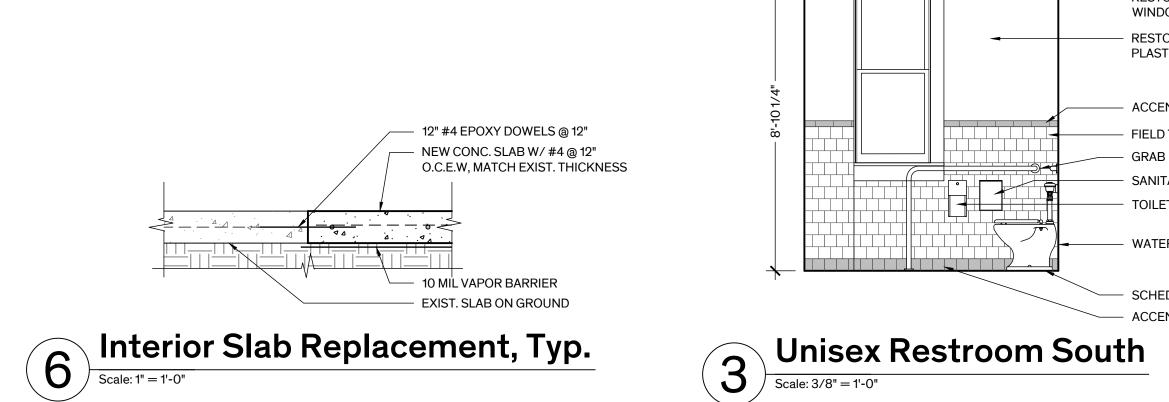

### TOILET ACCESSORIES SCHEDULE

л	ROOM NAME	ACCESSORIES										
		Wall Mounted Soap Dispenser	Towel Dispenser Trash Recept.	Toilet Tissue Dispenser	1'-6" X 3'-0" Mirror	36" Grab Bar	42" Grab Bar	Hand Dryer	Sanitary Waste Recept.	Baby Changing	Remarks	
	ADA / UNISEX	1	1	1	1	1	1	1	1	1		

GENERAL NOTE: COORDINATE FINAL LOCATION OF ACCESSORIES WITH ARCHITECT PRIOR TO INSTALLATION. WHERE TOILET ACCESSORIES ARE LOCATED ON BOTH PLASTER & TILE WALL FINISHES, INSTALL ITEM ON PLASTER WALL & BUTT TILE TO SIDE OF ACCESSORY ITEM, OR FRAME AROUND ITEM WITH ACCENT CAP TILE, TYP.

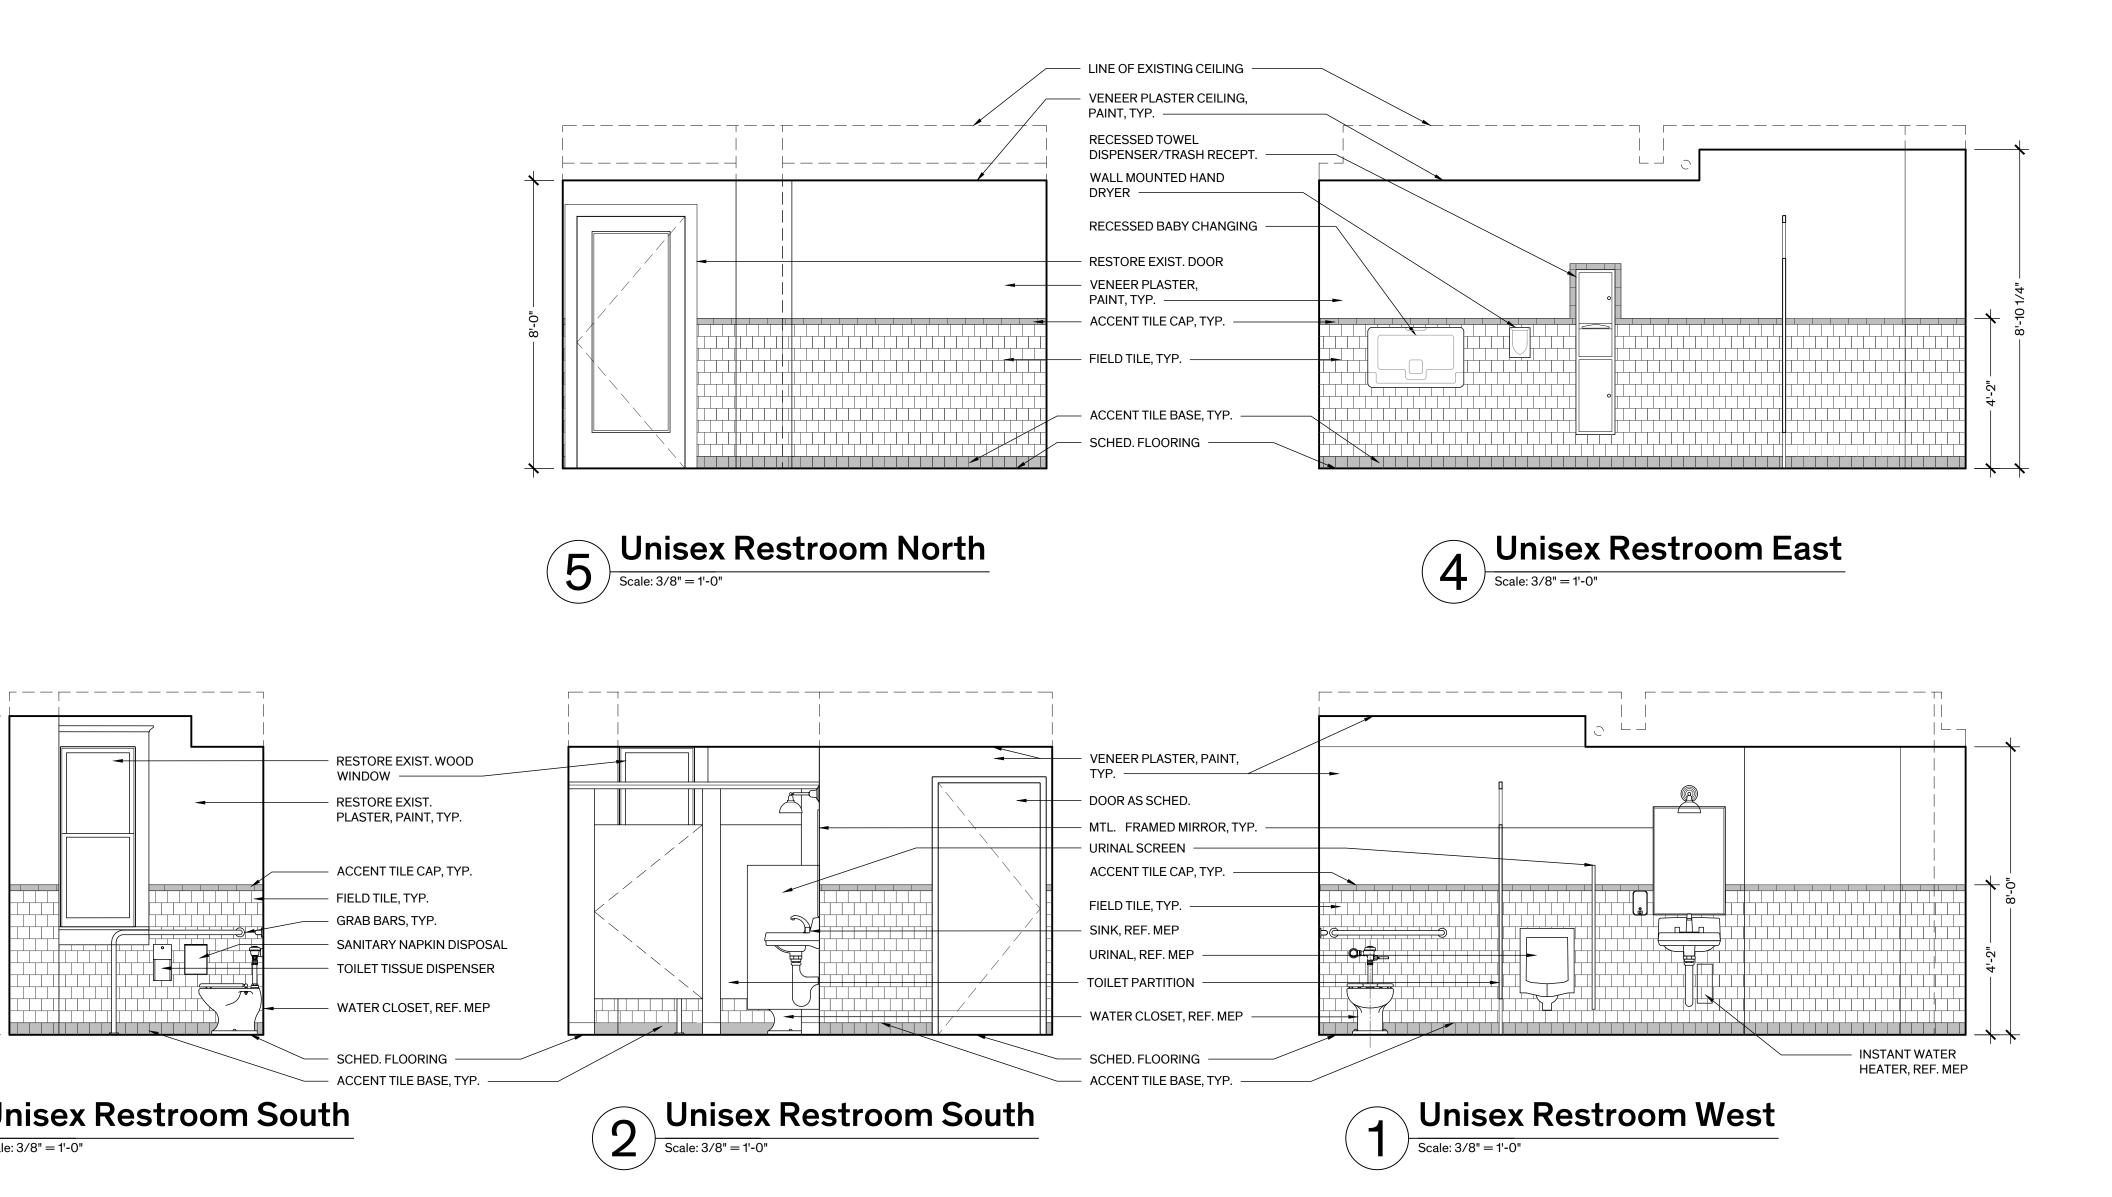

	ALTERNATES
	REFER TO SPEC. SECTION 01230 - /
5	ALTERNATE NO. 2: REHABILITATE MEN'S RESTROOM A UNISEX RESTROOM

**REFER TO SPEC. SECTION 01230 - ALTERNATES FOR DETAILED DESCRIPTION** 

ALTERNATE NO. 2: REHABILITATE MEN'S RESTROOM AT BASEMENT LEVEL TO ADA COMPLIANT UNISEX RESTROOM

# Architexas

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### DUVAL COUNTY COURTHOUSE

ROOF REMEDIATION. EXTERIOR WINDOWS, & ELECTRICAL

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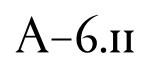
1. Issued for Bid


June 19, 2025


SEAL



Date Architexas No. 2433 6/19/2025 Sheet Name INTERIOR ELEVATIONS



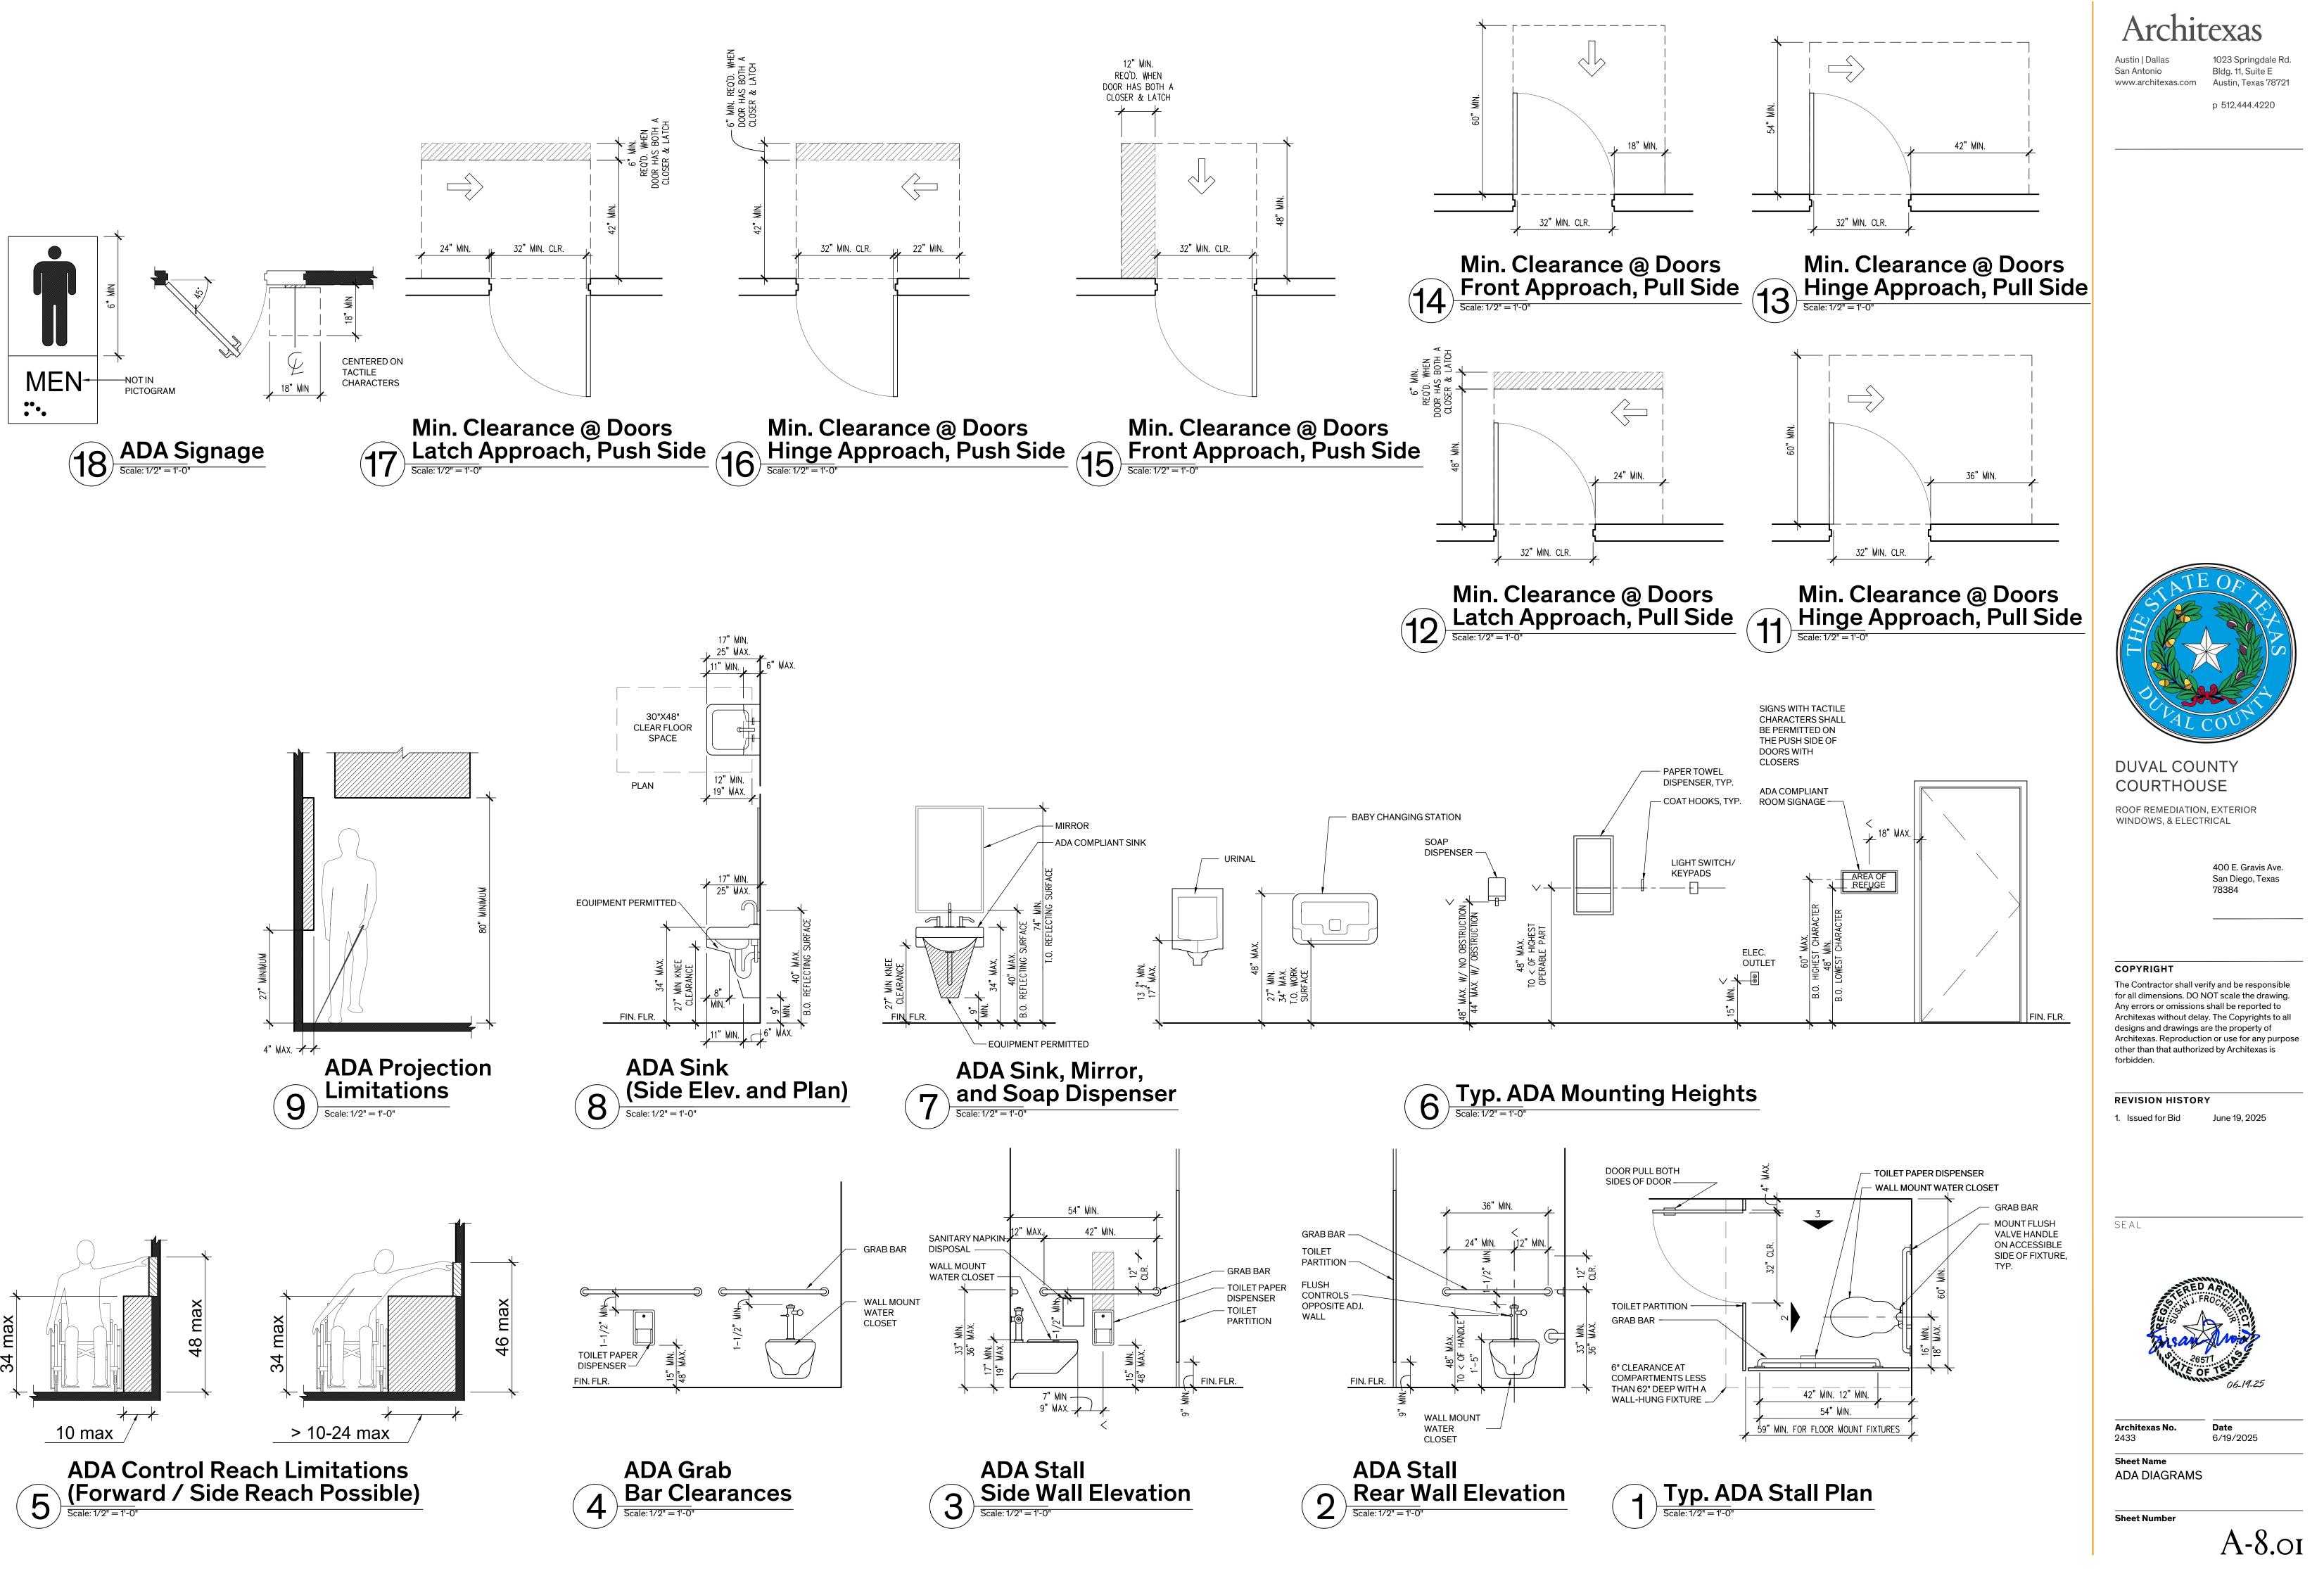

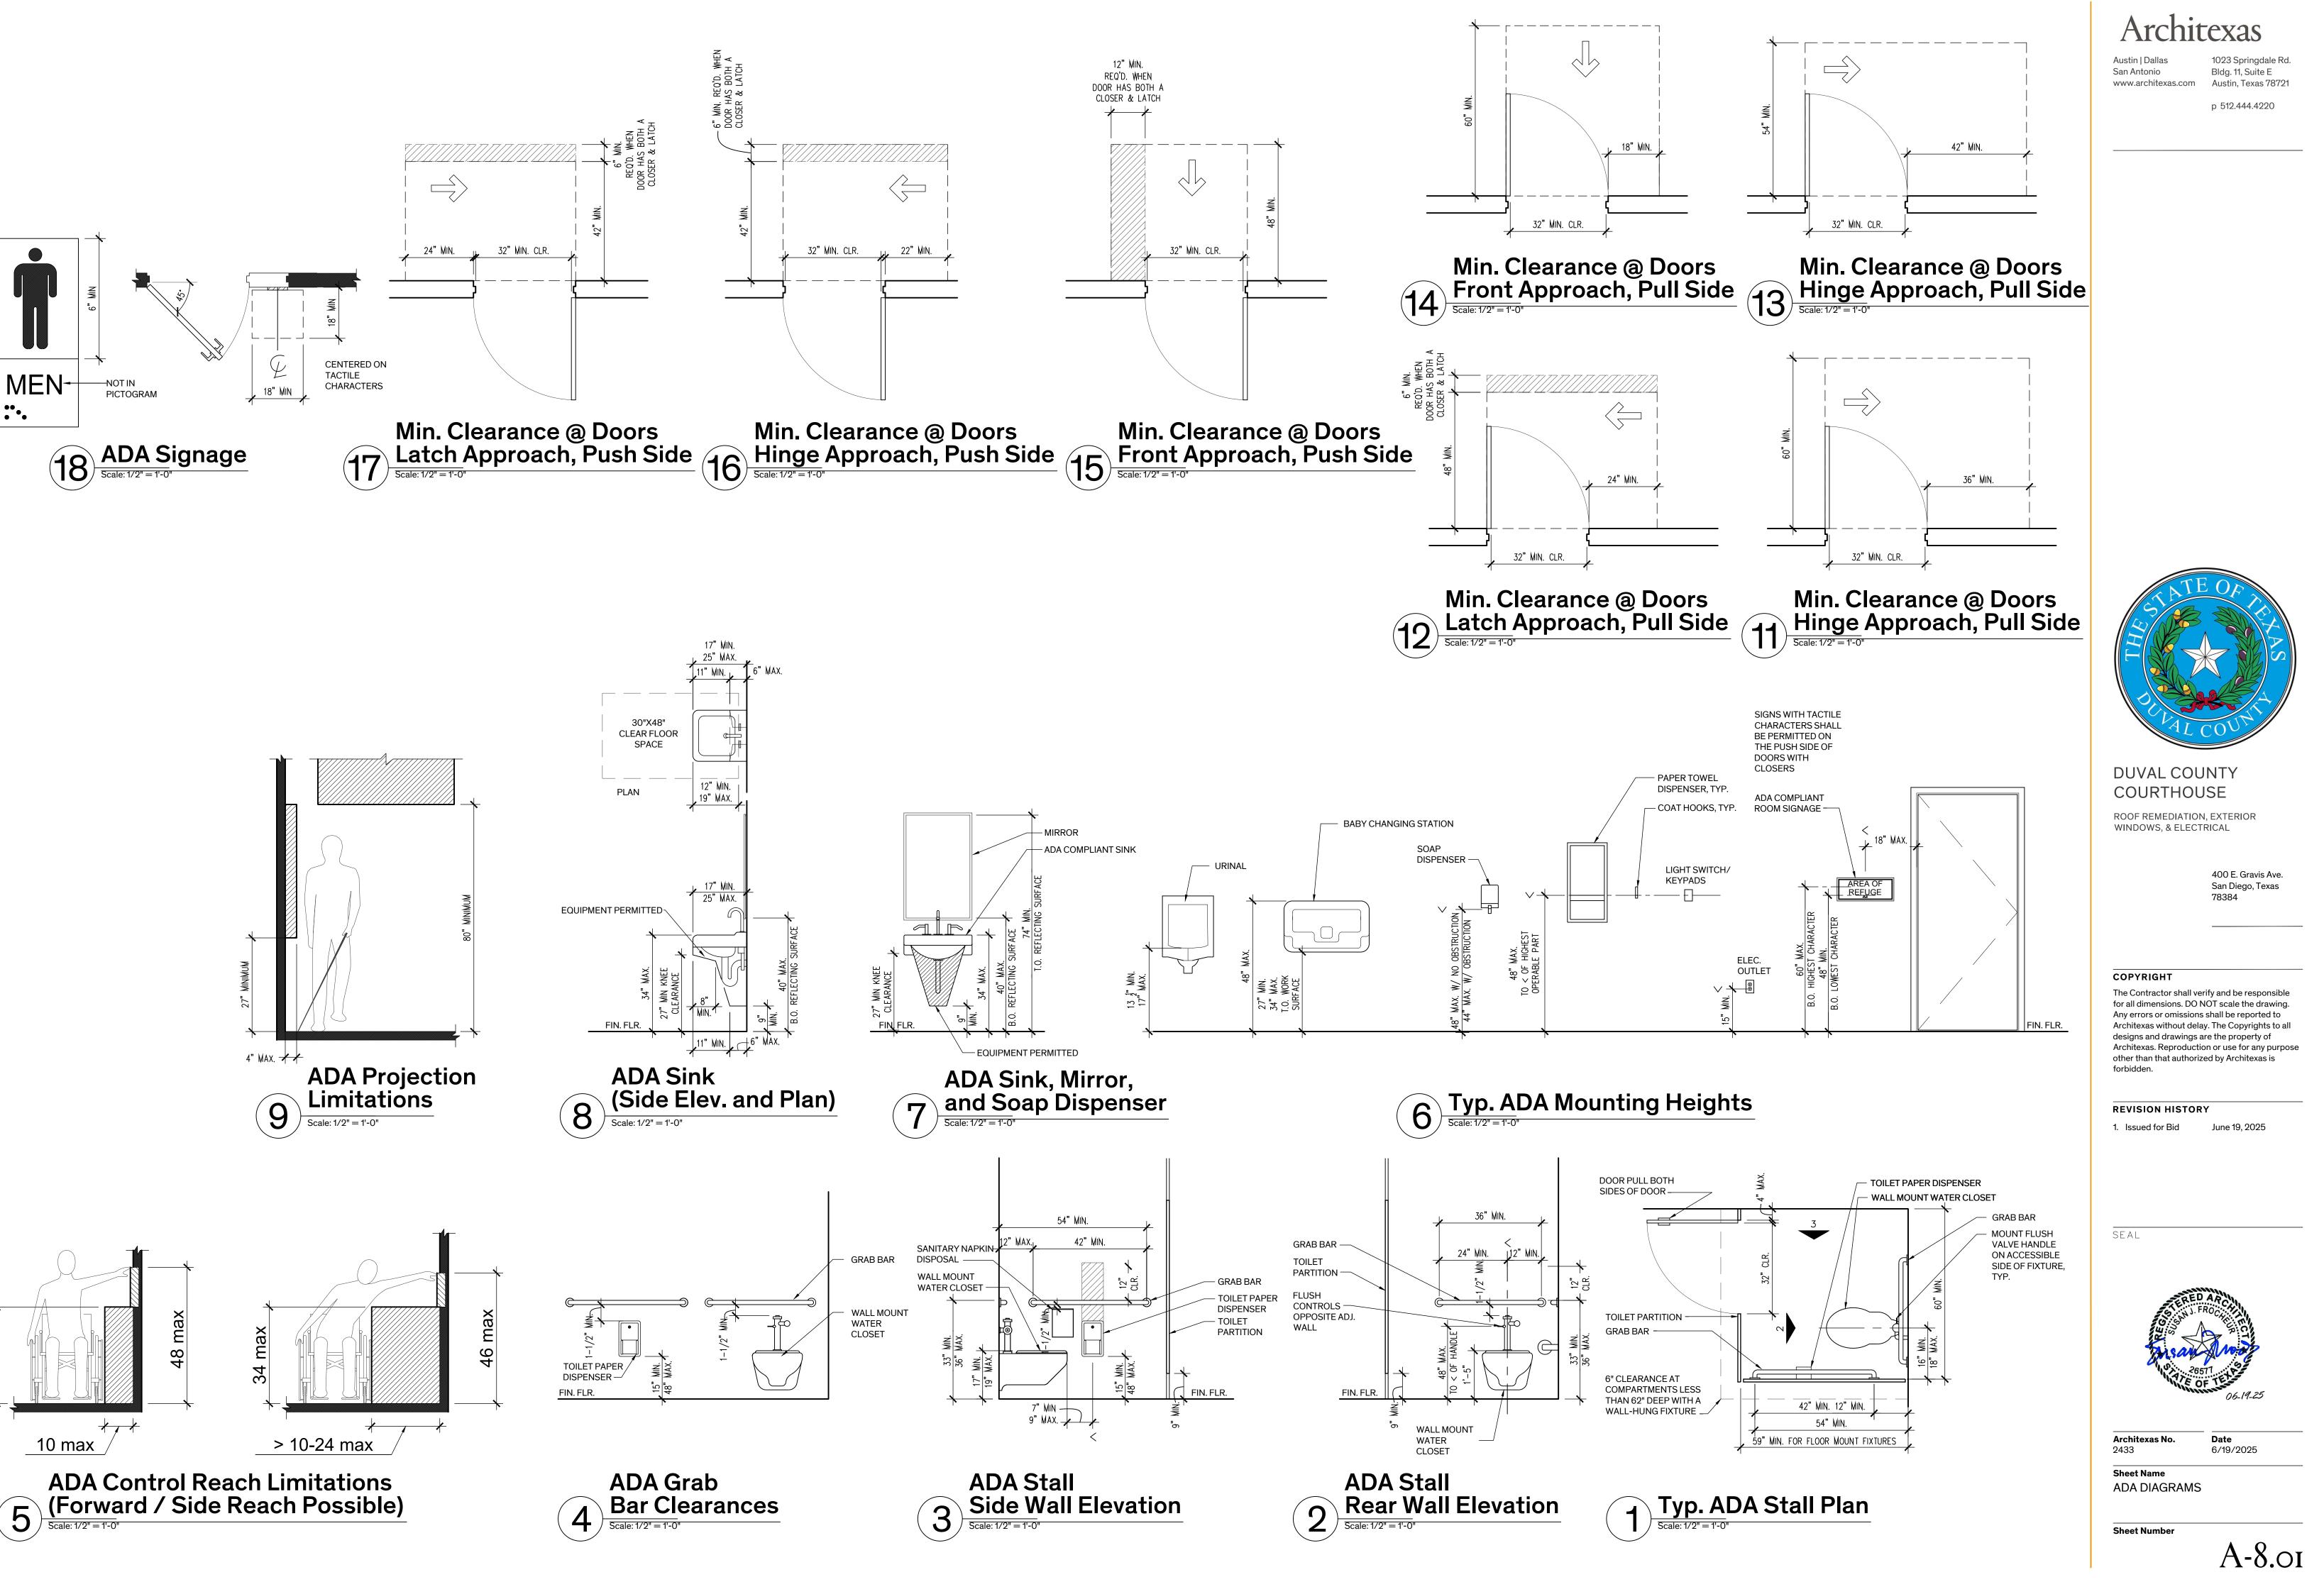

DUC	T LEGEND	GENERAL MECHANICAL A
NormalROUND DUCT UP AND DOWN8ØROUND DUCT WITH SIZE IN INCHESSIRADIUS ELBOW TURNING DOWNRADIUS ELBOW TURNING UP	TRANSITION - RECTANGULAR TO ROUND FIRE DAMPER RADIUS ELBOW	<ol> <li>THE CONTRACTOR SHALL FURNISH ALL LABOR, MAT MISCELLANEOUS ITEMS NOT SPECIFICALLY DESIGN/ CONTRACTOR SHALL COOPERATE WITH ALL TRADES ENGINEER, INSPECTOR, OR OTHER APPROPRIATE P</li> <li>WHILE SUBSTITUTIONS TO THOSE PRODUCTS SPEC ENGINEER TO APPROVE SUCH SUBSTITUTIONS.</li> <li>THE CONTRACTOR SHALL SECURE AND PAY FOR AN RELATED TO THE CONSTRUCTION.</li> </ol>
GRILLES, REGISTERS, A	ND DIFFUSERS (GRD) LEGEND	<ul> <li>4. PERFORM ALL WORK IN ACCORDANCE WITH THE CO BODY HAVING JURISDICTION, AS INTERPRETED BY T</li> <li>A. INTERNATIONAL BUILDING CODE (IBC) - 2021</li> <li>B. INTERNATIONAL MECHANICAL CODE (IMC) - 2021</li> <li>C. INTERNATIONAL PLUMBING CODE (IPC) - 2021</li> </ul>
-√-→ RETURN OR EXHAUST AIRFLO	W E EXHAUST	<ul> <li>D. INTERNATIONAL FIRE CODE (IFC) - 2021</li> <li>E. AMERICANS WITH DISABILITIES ACT (ADA)</li> <li>F. TEXAS ACCESSIBILITY STANDARDS (TAS)</li> </ul>
EQ	JIPMENT	G. WHERE THESE SPECIFICATIONS AND THE ACC REPORT THE MATTER TO THE ENGINEER FOR
EQUIPMENT TAG	EXAMPLE EQUIPMENT TAG:	<ol> <li>ALL MANUFACTURED ARTICLES SHALL BE APPLIED, I MANUFACTURER.</li> <li>ALL MATERIALS ARE NEW AND OF THE QUALITY SPE</li> <li>MATERIALS SHALL BE FREE FROM DEFECTS. ALL MA</li> </ol>
$\begin{array}{c} \text{EQUIPMENT} \longrightarrow \left[ \underbrace{\text{EEE}}_{1} \right]  \\ \text{TYPE}  \left[ \underbrace{\text{EEE}}_{1} \right]  \\ \text{NUMBER (1-9)} \end{array}$	AIR HANDLING <u>AHU-1</u> UNIT NUMBER	<ul> <li>INC. HAVE ESTABLISHED A STANDARD SHALL BE LIST THEIR LABEL.</li> <li>8. WHEREVER THE MAKE OF MATERIAL OR APPARATUS</li> </ul>
EQUIPMENT TYPE ABBREVIATION EF EXHAUST FAN L LOUVER	EXISTING MECHANICAL EQUIPMENT         MECHANICAL EQUIPMENT	<ul> <li>9. SUBMIT A SAMPLE TO THE ENGINEER BEFORE PROC</li> <li>9. SUBMITTALS:         <ul> <li>A. SUBMIT ALL SHOP DRAWINGS AT ONE TIME AS ENGINEER, CONTRACTOR, SUBCONTRACTOR SPECIFICATIONS AND SEPARATE FROM OTHE</li> <li>B. SHOP DRAWINGS SUBMITTED SHALL CONSIST OF THE EXACT ITEM OFFERED AND SHALL CL</li> </ul> </li> </ul>
PIPI	ELEGEND	<ul> <li>C. CONTRACTOR SHALL REVIEW SUBMITTALS FOOD OWN REVIEW STAMP OR STATEMENT BEFORE</li> <li>10. THE ENGINEER RESERVES THE RIGHT TO CALL FOR TOGETHER WITH A SAMPLE OF THE SPECIFIED MATE</li> </ul>
COLD WATER  HOT WATER  SANITARY SOIL LINE  REFRIGERANT LIQUID  RS REFRIGERANT SUCTION EXISTING TO REMAIN EVICTING TO REMAIN	Image: set of the set o	<ul> <li>MATERIAL AND/OR THE APPEARANCE IS INVOLVED, A MAY BE BETTER MADE BY VISUAL INSPECTION.</li> <li>11. ORDER OF PRECEDENCE SHALL BE OBSERVED IN LA MATERIAL INTO THE SPACE ABOVE THE CEILING AND GOVERN:         <ul> <li>A. LARGE DUCTS WITH CRITICAL CLEARANCES.</li> <li>B. CONDUIT AND OTHER LINES WHOSE ROUTING BY BENDS AND OFFSETS.</li> <li>C. ITEMS AFFECTING VISUAL APPEARANCE OF T COORDINATE ALL ITEMS TO AVOID CONFLICT</li> </ul> </li> <li>12. GUARANTEE:         <ul> <li>A. UNLESS A LONGER GUARANTEE IS HEREINAF SHALL BE GUARANTEED FOR A PERIOD OF OF</li> </ul> </li> </ul>
	SYMBOLS	<ul> <li>LABOR AND MATERIALS OCCURRING DURING SHALL BE IN WRITING AND IN TRIPLICATE.</li> <li>13. COMPLETION REQUIREMENTS:</li> <li>A. BEFORE ACCEPTANCE AND FINAL, FURNISH:</li> </ul>
E── PIPE CAP <u>WCO</u> '── WALL CLEAN OUT <u>FD</u> Ø FLOOR DRAIN	Image: Second state     Image: Second state       Imag	1)       ACCURATE RECORD DRAWINGS, SHOWALL CHANGES FROM THE ORIGINAL PL         2)       ALL MANUFACTURERS' GUARANTEES.         3)       ALL OPERATING MANUALS.
		1. DUCT HANGERS:     A. SUPPORT DUCTWORK IN FINISHED AREAS WI     2. PLUMBING PIPING:
GENER	AL SYMBOLS	A. DWV:
1 KEYED NOTE ABBF	CONNECT TO EXISTING	1)       CONFORM TO MSS SP69.         2)       HANGERS FOR PIPE SIZES 1/2 TO 1-1/2         3)       HANGERS FOR PIPE SIZES 2 INCHES AI         4)       MULTIPLE OR TRAPEZE HANGERS: STE         5)       COPPER PIPE SUPPORT: COPPER-PLAI
ABANTI-PERSONNEL BARSADACCESS DOORAFFABOVE FINISHED FLOORBTUHBRITISH THERMAL UNITS PER HOUFCFMCUBIC FEET PER MINUTECRUCOMPUTER ROOM UNITDBDRY BULB TEMPERATUREEAEXHAUST AIREATENTERING AIR TEMPERATUREEOMEND OF MAINESPEXTERNAL STATIC PRESSUREEWTENTERING WATER TEMPERATUREFDFIRE DAMPERFDFIRE SMOKE DAMPERGPHGALLONS PER HOURGPMGALLONS PER MINUTEHPHORSEPOWERLATLEAVING AIR TEMPERATURE	LWTLEAVING WATER TEMPERATUREMBHBTUH x 1000MCAMINIMUM CIRCUIT AMPACITYMOCPMAXIMUM OVER-CURRENT PROTECTIONOAOUTSIDE AIRPDPRESSURE DROPRARETURN AIRPHCPREHEAT COILRLARELIEF AIRRPMREVOLUTIONS PER MINUTESASUPPLY AIRSPSTATIC PRESSURETASTEXAS ACCESSIBILITY STANDARDTSPTOTAL STATIC PRESSUREWBWET BULB TEMPERATUREWPDWATER PRESSURE DROP	<ul> <li>B. WATER: <ol> <li>CONFORM TO MSS SP69.</li> <li>HANGERS FOR PIPE SIZES 1/2 TO 1-1/2</li> <li>HANGERS FOR COLD PIPE SIZES 2 INC</li> <li>COPPER PIPE SUPPORT: COPPER-PLA</li> </ol> </li> <li>ACCESSORIES: <ol> <li>A. HANGER RODS: MILD STEEL THREADED BOTH F593.</li> </ol> </li> <li>ANCHORS: <ol> <li>A. EXPANSION ANCHORS ARE FLUSH OR SHELL FOR EXPANSION SHIELD ANCHORS.</li> <li>A. EXPANSION ANCHORS ARE FLUSH OR SHELL FOR EXPANSION SHIELD ANCHORS.</li> <li>A. STM B633, ZINC PLATED.</li> <li>HILTI HDI; HDI-L.</li> </ol> </li> <li>SLEEVES: <ol> <li>SLEEVES:</li> <li>SLEEVES FOR PIPES THROUGH NON FIRE RATED STEEL PIPE.</li> <li>SLEEVES FOR PIPES THROUGH NON FIRE RATED A PREFABRICATED FIRE RATED SLEEVES INCLUD.</li> <li>SLEEVES FOR ROUND DUCTWORK: GALVANIZ</li> <li>SLEEVES FOR RECTANGULAR DUCTWORK: GALVANIZ</li> <li>SLEEVES FOR RECTANGULAR DUCTWORK: GA</li> <li>F. FIRE-STOPPING INSULATION: GLASS FIBER T</li> <li>SLEEVES FOR RECTANGULAR DUCTWORK: GA</li> <li>F. FIRE-STOPPING INSULATION: GLASS FIBER T</li> <li>SLEALANT: ACRYLIC INTUMESCENT.</li> </ol> </li> <li>INSTALL HANGERS TO PROVIDE MINIMUM ½ IN B. PLACE HANGERS WITHIN 12 INCHES OF EACH</li> <li>USE HANGERS WITH 1-1/2 INCH MINIMUM VER</li> <li>SUPPORT HORIZONTAL CAST IRON PIPE ADJA HANGERS.</li> <li>WHERE SEVERAL PIPES CAN BE INSTALLED IN TRAPEZE HANGERS.</li> </ul>

# MECHANICAL A

- BUILDING CODE (IBC) 2021 MECHANICAL CODE (IMC) - 20 \_ PLUMBING CODE (IPC) - 2021 \_ FIRE CODE (IFC) - 2021 TH DISABILITIES ACT (ADA) SIBILITY STANDARDS (TAS) SPECIFICATIONS AND THE ACC
- IATTER TO THE ENGINEER FOR ARTICLES SHALL BE APPLIED, I NEW AND OF THE QUALITY SPEC
- FREE FROM DEFECTS. ALL MA IED A STANDARD SHALL BE LIST
- E OF MATERIAL OR APPARATUS THE ENGINEER BEFORE PROC
- HOP DRAWINGS AT ONE TIME AS NTRACTOR, SUBCONTRACTOR, IS AND SEPARATE FROM OTHE GS SUBMITTED SHALL CONSIST
- ITEM OFFERED AND SHALL CLE SHALL REVIEW SUBMITTALS FO TAMP OR STATEMENT BEFORE
- RVES THE RIGHT TO CALL FOR 3 MPLE OF THE SPECIFIED MATE E APPEARANCE IS INVOLVED, 1 E BY VISUAL INSPECTION.
- NCE SHALL BE OBSERVED IN LA PACE ABOVE THE CEILING AND
- WITH CRITICAL CLEARANCES. OTHER LINES WHOSE ROUTING OFFSETS.
- ING VISUAL APPEARANCE OF TH ALL ITEMS TO AVOID CONFLICTS
- GER GUARANTEE IS HEREINAF RANTEED FOR A PERIOD OF ON TERIALS OCCURRING DURING RITING AND IN TRIPLICATE.
- MENTS:
  - PTANCE AND FINAL, FURNISH:
  - TE RECORD DRAWINGS, SHO ANGES FROM THE ORIGINAL PL
  - NUFACTURERS' GUARANTEES.
  - ERATING MANUALS.

- RM TO MSS SP69. RS FOR PIPE SIZES 1/2 TO 1-1/2 RS FOR PIPE SIZES 2 INCHES AN
- E OR TRAPEZE HANGERS: STE
- R PIPE SUPPORT: COPPER-PLA
- RM TO MSS SP69.
- RS FOR PIPE SIZES 1/2 TO 1-1/2
- RS FOR COLD PIPE SIZES 2 INCI
- R PIPE SUPPORT: COPPER-PLA
- : MILD STEEL THREADED BOTH
- CHORS ARE FLUSH OR SHELL N SHIELD ANCHORS.
- NC PLATED.
- PIPES THROUGH NON FIRE RAT PIPES THROUGH NON FIRE RAT
- PIPES THROUGH FIRE RATED A ED FIRE RATED SLEEVES INCLU
- ROUND DUCTWORK: GALVANIZ
- RECTANGULAR DUCTWORK: GA
- G INSULATION: GLASS FIBER T
- YLIC INTUMESCENT.
- ERS TO PROVIDE MINIMUM 1/2 IN
- RS WITHIN 12 INCHES OF EACH
- WITH 1-1/2 INCH MINIMUM VER
- RIZONTAL CAST IRON PIPE ADJA
- RAL PIPES CAN BE INSTALLED IN ERS

L MECHANICAL AND PLUMBING SPECIFICATIONS	HANGERS AND SUPPORTS (CONT.)
SHALL FURNISH ALL LABOR, MATERIALS, EQUIPMENT, AND OTHER RELATED ITEMS, INCLUDING EMS NOT SPECIFICALLY DESIGNATED, TO COMPLETE THE FULLY FUNCTIONING SYSTEMS. THE L COOPERATE WITH ALL TRADES INVOLVED ON THE PROJECT, AND SHALL AFFORD THE OWNER, OR, OR OTHER APPROPRIATE PERSONNEL EVERY OPPORTUNITY TO INSPECT THE PROJECT. INS TO THOSE PRODUCTS SPECIFIED MAY BE MADE, IT SHALL BE AT THE DISCRETION OF THE OVE SUCH SUBSTITUTIONS.	<ul> <li>F. SUPPORT RISER PIPING INDEPENDENTLY OF CONNECTED HORIZONTAL PIPING.</li> <li>G. PROVIDE COPPER PLATED HANGERS AND SUPPORTS FOR COPPER PIPING.</li> <li>H. DESIGN HANGERS FOR PIPE MOVEMENT WITHOUT DISENGAGEMENT OF SUPPORTED PIPE.</li> </ul>
SHALL SECURE AND PAY FOR ANY AND ALL PERMITS, FEES, INSPECTIONS, AND OTHER ITEMS	1. NAMEPLATES:
ONSTRUCTION. K IN ACCORDANCE WITH THE CODES LISTED BELOW AS WELL AS THE CODES OF ANY OTHER LEGAL SDICTION, AS INTERPRETED BY THE INSPECTING AUTHORITY.	<ul> <li>NAMEPLATES.</li> <li>A. MANUFACTURERS: CRAFTMARK IDENTIFICATION SYSTEMS, SAFETY SIGN CO, SETON IDENTIFICATION PRODUCTS, MARKING SERVICES INC.</li> <li>B. PRODUCT DESCRIPTION: LAMINATED THREE-LAYER PLASTIC WITH ENGRAVED WHITE LETTERS ON BLACK</li> </ul>
IAL BUILDING CODE (IBC) - 2021 IAL MECHANICAL CODE (IMC) - 2021	BACKGROUND. MINIMUM 1-1/2" X 4" SIZE WITH 16 POINT HELVETICA FONT.
IAL PLUMBING CODE (IPC) - 2021	METAL TAGS:     A. MANUFACTURERS: SETON IDENTIFICATION PRODUCTS, MARKING SERVICES INC.
IAL FIRE CODE (IFC) - 2021 WITH DISABILITIES ACT (ADA)	B. BRASS WITH STAMPED LETTERS; TAG SIZE MINIMUM 1-1/2 INCHES WITH SMOOTH EDGES.
SSIBILITY STANDARDS (TAS)	PIPE MARKERS:     A. COLOR AND LETTERING: CONFORM TO ASME A13.1.
SE SPECIFICATIONS AND THE ACCOMPANYING DRAWINGS CONFLICT WITH THESE REQUIREMENTS, MATTER TO THE ENGINEER FOR CLARIFICATION.	B. PLASTIC PIPE MARKERS:
D ARTICLES SHALL BE APPLIED, INSTALLED AND HANDLED AS RECOMMENDED BY THE	<ol> <li>MANUFACTURERS: SETON SETMARK, CRAFTMARK IDENTIFICATION SYSTEMS, MARKING SERVICES INC.</li> <li>FACTORY FABRICATED, FLEXIBLE, SEMI-RIGID PLASTIC, PREFORMED TO FIT AROUND PIPE OR PIPE COVERING. LARGER SIZES MAY HAVE MAXIMUM SHEET SIZE WITH SPRING FASTENER.</li> </ol>
E FREE FROM DEFECTS. ALL MATERIALS OF A TYPE FOR WHICH THE UNDERWRITERS LABORATORIES, HED A STANDARD SHALL BE LISTED BY THE UNDERWRITERS LABORATORIES, INC. AND SHALL BEAR	<ul> <li>C. PLASTIC TAPE PIPE MARKERS:</li> <li>1) MANUFACTURERS: SETON IDENTIFICATION PRODUCTS, CRAFTMARK IDENTIFICATION SYSTEMS, MARKING SERVICES INC.</li> </ul>
KE OF MATERIAL OR APPARATUS REQUIRED IS NOT DEFINITELY SPECIFIED, THE CONTRACTOR SHALL O THE ENGINEER BEFORE PROCEEDING.	<ul> <li>2) FLEXIBLE, VINYL FILM TAPE WITH PRESSURE SENSITIVE ADHESIVE BACKING AND PRINTED MARKINGS.</li> <li>4. INSTALLATION:</li> </ul>
SHOP DRAWINGS AT ONE TIME AS A BOUND PDF PORTFOLIO IDENTIFYING PROJECT, ARCHITECT, ONTRACTOR, SUBCONTRACTOR, AND SUPPLIER. INDEX EACH SECTION ACCORDING TO THE DNS AND SEPARATE FROM OTHER SECTIONS. NGS SUBMITTED SHALL CONSIST OF MANUFACTURER'S SUBMITTAL DATA THAT CONTAIN INDICATION	<ul> <li>A. INSTALL IDENTIFYING DEVICES AFTER COMPLETION OF COVERINGS AND PAINTING.</li> <li>B. INSTALL LABELS WITH SUFFICIENT ADHESIVE TO ENSURE PERMANENT ADHESION AND SEAL WITH CLEAR LACQUER. FOR UNFINISHED CANVAS COVERING, APPLY PAINT PRIMER BEFORE APPLYING LABELS.</li> <li>C. INSTALL TAGS USING CORROSION RESISTANT CHAIN. NUMBER TAGS CONSECUTIVELY BY LOCATION.</li> </ul>
T ITEM OFFERED AND SHALL CLEARLY IDENTIFY THE ITEM WITH THE PROJECT. R SHALL REVIEW SUBMITTALS FOR COMPLIANCE TO PROJECT REQUIREMENTS AND APPLY THEIR / STAMP OR STATEMENT BEFORE FORWARDING TO THE ENGINEER FOR REVIEW.	<ul> <li>D. IDENTIFY PIPING, CONCEALED OR EXPOSED, WITH PLASTIC PIPE MARKERS OR PLASTIC TAPE PIPE MARKERS.</li> <li>E. IDENTIFY SERVICE, FLOW DIRECTION, AND PRESSURE.</li> <li>F. INSTALL IN CLEAR VIEW AND ALIGN WITH AXIS OF PIPING.</li> </ul>
ERVES THE RIGHT TO CALL FOR SAMPLES OF ANY ITEM OF MATERIAL OFFERED IN SUBSTITUTION, SAMPLE OF THE SPECIFIED MATERIAL, WHEN, IN THE ENGINEER'S OPINION, THE QUALITY OF THE HE APPEARANCE IS INVOLVED, AND IT IS DEEMED THAT AN EVALUATION OF THE TWO MATERIALS DE BY VISUAL INSPECTION.	<ul> <li>G. LOCATE IDENTIFICATION NOT TO EXCEED 20 FEET ON STRAIGHT RUNS INCLUDING RISERS AND DROPS.</li> <li>H. LOCATE IDENTIFICATION ADJACENT TO EACH VALVE AND TEE, AT EACH SIDE OF PENETRATION OF STRUCTURE OR ENCLOSURE, AND AT EACH OBSTRUCTION.</li> </ul>
ENCE SHALL BE OBSERVED IN LAYING OUT THE DUCTWORK AND MATERIAL IN ORDER TO FIT THE SPACE ABOVE THE CEILING AND IN THE CHASES AND WALLS. THE FOLLOWING ORDER SHALL	I. IDENTIFY VALVES IN MAIN AND BRANCH PIPING WITH TAGS. PLUMBING EQUIPMENT
S WITH CRITICAL CLEARANCES. D OTHER LINES WHOSE ROUTING IN NOT CRITICAL AND WHOSE FUNCTION WOULD NOT BE IMPAIRED	1. ELECTRIC TANKLESS WATER HEATERS:
ID OFFSETS. TING VISUAL APPEARANCE OF THE INSIDE OF THE BUILDING SUCH AS DIFFUSERS, GRILLES, ETC.	<ul> <li>A. MANUFACTURER: EEMAX FLOWCO</li> <li>B. GENERAL:</li> </ul>
	<ol> <li>UNIT SHALL HAVE ABS-UL 94 5VA RATED COVER.</li> <li>INTEGRAL FEATURES:</li> </ol>
NGER GUARANTEE IS HEREINAFTER CALLED FOR, ALL WORK, MATERIAL AND EQUIPMENT ITEMS ARANTEED FOR A PERIOD OF ONE YEAR AFTER ACCEPTANCE BY THE OWNER. ALL DEFECTS IN IATERIALS OCCURRING DURING THIS PERIOD SHALL BE REPAIRED AND/OR REPLACED. GUARANTEE WRITING AND IN TRIPLICATE.	<ol> <li>ELEMENT SHALL BE REPLACEABLE CARTRIDGE INSERT. ELEMENT SHALL BE IRON-FREE, NICKEL-CHROME MATERIAL.</li> <li>UNIT SHALL INCLUDE AN INTEGRATED FLOW METER TO ENSURE ACCURATE TURN-ON / TURN-OFF FLOW</li> </ol>
	RATE. 3) DIAGNOSTIC FEATURES TO INCLUDE LED ERROR/FAULT INDICATOR. HEATER SHALL EMPLOY TECHNOLOGY
EPTANCE AND FINAL, FURNISH: RATE RECORD DRAWINGS, SHOWN IN RED INK ON BLUE LINE PRINTS FURNISHED FOR THAT PURPOSE HANGES FROM THE ORIGINAL PLANS MADE DURING INSTALLATION OF THE WORK.	<ul> <li>THAT ENGAGES UPON START-UP TO AVOID DRY-FIRE OCCURRENCE.</li> <li>4) CONTROL SYSTEM ACTIVATES HEATER ONLY ON DEMAND.</li> <li>5) HIGH TEMPERATURE LIMIT SWITCH ENABLES SAFE OPERATION.</li> </ul>
ANUFACTURERS' GUARANTEES. PERATING MANUALS.	6) 5-YEAR LIMITED WARRANTY ON LEAKS, 1-YEAR ON PARTS.
HANGERS AND SUPPORTS	<ul> <li>7) MAXIMUM OPERATING PRESSURE OF 150 PSI.</li> <li>8) DISCHARGE HOT WATER TEMPERATURE SHALL BE FACTORY SET TO 110 DEGREES F.</li> <li>D. PERFORMANCE:</li> </ul>
CTWORK IN FINISHED AREAS WITH STRAP HANGERS IN ACCORDANCE WITH SMACNA.	<ol> <li>REFER TO CONSTRUCTION DRAWINGS FOR INDIVIDUAL UNIT PERFORMANCE AND ELECTRICAL DATA.</li> <li>INSTALLATION:</li> </ol>
ORM TO MSS SP69.	<ul> <li>A. INSTALL WATER HEATERS IN ACCORDANCE WITH MANUFACTURER'S INSTRUCTIONS AND TO NSF, NFPA 54, UL REQUIREMENTS.</li> <li>B. COORDINATE WITH PLUMBING PIPING AND ELECTRICAL WORK TO ACHIEVE OPERATING SYSTEM.</li> </ul>
ERS FOR PIPE SIZES 1/2 TO 1-1/2 INCH: CARBON STEEL, ADJUSTABLE SWIVEL, SPLIT RING.	
ERS FOR PIPE SIZES 2 INCHES AND OVER: CARBON STEEL, ADJUSTABLE CLEVIS. PLE OR TRAPEZE HANGERS: STEEL CHANNELS WITH WELDED SPACERS AND HANGER RODS. ER PIPE SUPPORT: COPPER-PLATED, CARBON-STEEL ADJUSTABLE, RING.	INSULATION         1.       GLASS FIBER PIPE INSULATION:         A.       MANUFACTURERS: KNAUF, JOHNS-MANVILLE, OWENS-CORNING.
ORM TO MSS SP69.	<ul> <li>B. INSULATION: ASTM C547; RIGID MOLDED, NONCOMBUSTIBLE.</li> <li>1) 'K' VALUE: ASTM C177, 0.24 AT 75 DEGREES F.</li> </ul>
ERS FOR PIPE SIZES 1/2 TO 1-1/2 INCH: CARBON STEEL, ADJUSTABLE SWIVEL, SPLIT RING. ERS FOR COLD PIPE SIZES 2 INCHES AND OVER: CARBON STEEL, ADJUSTABLE CLEVIS.	2) MAXIMUM SERVICE TEMPERATURE: 850 DEGREES F.
ER PIPE SUPPORT: COPPER-PLATED, CARBON-STEEL ADJUSTABLE, RING	<ul> <li>3) MAXIMUM MOISTURE ABSORPTION: 0.2 PERCENT BY VOLUME.</li> <li>C. VAPOR BARRIER JACKET:</li> </ul>
DS: MILD STEEL THREADED BOTH ENDS, THREADED ON ONE END, OR CONTINUOUS THREADED. ASTM	<ol> <li>ASTM C921, WHITE KRAFT PAPER WITH GLASS FIBER YARN, BONDED TO ALUMINIZED FILM.</li> <li>MOISTURE VAPOR TRANSMISSION: ASTM E96; 0.02 PERM-INCHES.</li> <li>VAPOR BARRIER LAP ADHESIVE:</li> </ol>
ANCHORS ARE FLUSH OR SHELL TYPE MEETING FEDERAL SPECIFICATION FF-S-325, GROUP VIII TYPE 1, ION SHIELD ANCHORS.	<ol> <li>MANUFACTURERS: CHILDERS CP-82, FOSTERS 85-20</li> <li>COMPATIBLE WITH INSULATION.</li> </ol>
INC PLATED. I-L.	<ul><li>E. INSULATING CEMENT/MASTIC:</li><li>1) ASTM C195; HYDRAULIC SETTING ON MINERAL WOOL</li></ul>
	2. INSTALLATION - PIPING:
R PIPES THROUGH NON FIRE RATED FLOORS: 18 GAGE THICK GALVANIZED STEEL. R PIPES THROUGH NON FIRE RATED BEAMS, WALLS, FOOTINGS, AND POTENTIALLY WET FLOORS:	<ul> <li>A. INSTALL IN ACCORDANCE WITH NAIMA NATIONAL INSULATION STANDARDS.</li> <li>B. INSULATED PIPES CONVEYING FLUIDS BELOW AND ABOVE AMBIENT TEMPERATURE:</li> <li>1) INSULATE ENTIRE SYSTEM INCLUDING FITTINGS, VALVES, UNIONS, FLANGES, STRAINERS, FLEXIBLE</li> </ul>
R PIPES THROUGH FIRE RATED AND FIRE RESISTIVE FLOORS AND WALLS, AND FIREPROOFING: TED FIRE RATED SLEEVES INCLUDING SEALS, UL LISTED. R ROUND DUCTWORK: GALVANIZED STEEL.	CONNECTIONS, AND EXPANSION JOINTS. C. CONTINUE INSULATION THROUGH WALLS, SLEEVES, PIPE HANGERS, AND OTHER PIPE PENETRATIONS. FINISH AT SUPPORTS, PROTRUSIONS, AND INTERRUPTIONS.
R RECTANGULAR DUCTWORK: GALVANIZED STEEL.	3. SCHEDULES: A. PLUMBING SYSTEMS:
ING INSULATION: GLASS FIBER TYPE, NON-COMBUSTIBLE. RYLIC INTUMESCENT.	A.     PLOMBING SYSTEMS:       1)     DOMESTIC HOT WATER:
NG:	a. GLASS FIBER INSULATION:
GERS TO PROVIDE MINIMUM ½ INCH SPACE BETWEEN FINISHED COVERING AND ADJACENT WORK. ERS WITHIN 12 INCHES OF EACH HORIZONTAL ELBOW. S WITH 1-1/2 INCH MINIMUM VERTICAL ADJUSTMENT.	<ul> <li>b. PIPE SIZE RANGE: ALL SIZES - THICKNESS: 1 INCH.</li> <li>2) DOMESTIC COLD WATER:</li> <li>a. GLASS FIBER INSULATION:</li> </ul>
RIZONTAL CAST IRON PIPE ADJACENT TO EACH HUB, WITH 5 FEET MAXIMUM SPACING BETWEEN	b. PIPE SIZE RANGE: ALL SIZES - THICKNESS: 1/2 INCH.
RAL PIPES CAN BE INSTALLED IN PARALLEL AND AT SAME ELEVATION, PROVIDE MULTIPLE OR NGERS.	

### PLUMBING PIPING, VALVES, AND SPECIALTIES

### 1. SANITARY SEWER PIPING:

- A. PVC PIPE: ASTM D2665, POLYVINYL CHLORIDE (PVC) MATERIAL.
  - 1) FITTINGS: ASTM D2665, PVC.
  - JOINTS: ASTM D2855, SOLVENT WELD WITH ASTM D2564 SOLVENT CEMENT.
- 2. DOMESTIC WATER PIPING:
  - A. COPPER TUBING: ASTM B88, TYPE L, HARD DRAWN.
    - FITTINGS: ASME B16.22, WROUGHT COPPER OR PROPRESS.
  - 2) JOINTS: ASTM B32, SOLDER, GRADE 95TA.
- 3. FLOOR DRAINS <u>2" FD</u>
  - MANUFACTURERS: WADE MODEL W-1100, ZURN MODEL Z-415-B. Α.
  - B. ANSI A112.21.1; LACQUERED CAST IRON TWO PIECE BODY WITH DOUBLE DRAINAGE FLANGE, WEEP HOLES, REVERSIBLE CLAMPING COLLAR, AND ROUND ADJUSTABLE NICKEL-BRONZE STRAINER.
  - ACCESSORIES: C.
    - 1) PROVIDE EACH FLOOR DRAIN WITH ELASTOMERIC PVC DUCKBILL INSERT AS MANUFACTURED BY TRAP GUARD®.
      - a. SURESEAL® TRAP SEALS AS MANUFACTURED BY RECTORSEAL ARE ACCEPTABLE.

4. BALL VALVES:

Β.

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- MANUFACTURERS: NIBCO MODEL T-585-66-LF
- CONSTRUCTION, 3 INCHES AND SMALLER: NSF/ANSI 61, LEAD FREE, MSS SP-110, CLASS 150, 600 PSI CWP, BRONZE TWO-PIECE BODY, STAINLESS STEEL BALL, FULL PORT, TEFLON SEATS AND STUFFING BOX RING, BLOW-OUT PROOF STAINLESS STEEL STEM, LEVER HANDLE THREADED ENDS.

SWING CHECK VALVES

- A. UP TO AND INCLUDING 3 INCHES:
  - 1) MANUFACTURERS: NIBCO MODEL T-413-Y-LF
  - 2) NSF/ANSI 61, LEAD FREE, MSS SP-80, CLASS 150, BRONZE BODY AND CAP, PTFE SWING DISC WITH RENEWABLE SEAT, THREADED ENDS.

WATER HAMMER ARRESTORS:

- MANUFACTURER: SIOUX CHIEF, PPP Α.
- ANSI 1010-2004; PISTON TYPE, TYPE L COPPER TUBE CONSTRUCTION, POLY-PISTON WITH EPDM O-RINGS. R
- SIZED IN ACCORDANCE WITH MANUFACTURER REQUIREMENTS SUITABLE FOR OPERATION IN TEMPERATURE C. RANGE -100 TO 300 DEGREES F MAXIMUM 250 PSI WORKING PRESSURE.
- 7. PREPARATION:
  - REAM PIPE AND TUBE ENDS. REMOVE BURRS. BEVEL PLAIN END FERROUS PIPE. Α.
  - REMOVE SCALE AND DIRT, INSIDE AND OUTSIDE, BEFORE ASSEMBLY. Β.
  - PREPARE PIPING CONNECTIONS TO EQUIPMENT WITH FLANGES OR UNIONS.

INSTALLATION:

- A. INSTALL IN ACCORDANCE WITH MANUFACTURER'S INSTRUCTIONS.
- ROUTE PIPING IN ORDERLY MANNER AND MAINTAIN GRADIENT. ROUTE PARALLEL AND PERPENDICULAR TO Β. WALLS.
- C. INSTALL PIPING TO MAINTAIN HEADROOM, CONSERVE SPACE, AND NOT INTERFERE WITH USE OF SPACE.
- D. INSTALL PIPING TO ALLOW FOR EXPANSION AND CONTRACTION WITHOUT STRESSING PIPE, JOINTS, OR CONNECTED EQUIPMENT.
- F PROVIDE CLEARANCE IN HANGERS AND FROM STRUCTURE AND OTHER EQUIPMENT FOR INSTALLATION OF INSULATION AND FITTINGS.
- INSTALL VALVES WITH STEMS UPRIGHT OR HORIZONTAL, NOT INVERTED. F
- G. PROVIDE ACCESS WHERE VALVES AND FITTINGS ARE NOT ACCESSIBLE.
- INSTALL NON-CONDUCTING DIELECTRIC CONNECTIONS WHEREVER JOINTING DISSIMILAR METALS. H.
- INSTALL WATER PIPING TO ASME B31.9.
- J. SLEEVE PIPES PASSING THROUGH PARTITIONS, WALLS, AND FLOORS.
- K. INSTALL WATER HAMMER ARRESTORS COMPLETE WITH ACCESSIBLE ISOLATION VALVE ON HOT AND COLD WATER SUPPLY PIPING TO EACH GROUP OF PLUMBING FIXTURES.

9. ERECTION TOLERANCES:

- A. ESTABLISH INVERT ELEVATIONS, SLOPES FOR DRAINAGE TO 1/8 INCH PER FOOT MINIMUM, MAINTAIN GRADIENTS 10. TESTING:
  - A. TEST ALL PIPES BEFORE THEY ARE INSULATED, PAINTED, OR OTHERWISE COVERED UP OR RENDERED
  - INACCESSIBLE. ACCOMPLISH TESTING BY SECTIONS OF LINES OR SYSTEMS, AS REQUIRED BY CONDITIONS DURING В CONSTRUCTION. CLEAN ALL PIPING AND EQUIPMENT BEFORE TESTING.

### **DUCTS AND DUCT ACCESSORIES**

### 1. DUCT MATERIALS:

A. GALVANIZED STEEL DUCTS: G90 OR BETTER GALVANIZED STEEL SHEET, LOCK FORMING QUALITY (LFQ), CHEM TREAT.

B. FASTENERS: RIVETS, BOLTS, OR SHEET METAL SCREWS.

2. DUCTWORK FABRICATION:

- A. FABRICATE AND SUPPORT IN ACCORDANCE WITH SMACNA HVAC DUCT CONSTRUCTION STANDARDS METAL AND FLEXIBLE, AND AS INDICATED.
- PROVIDE DUCT MATERIAL, GAGES, REINFORCING, AND SEALING FOR OPERATING PRESSURES INDICATED. Β.
- C. TRANSVERSE DUCT JOINTS: REFER TO MANUFACTURER'S GUIDELINES FOR SHEET GAUGE, INTERMEDIATE REINFORCEMENT SIZE AND SPACING AND JOINT REINFORCEMENTS.
- D. MAKE LONGITUDINAL SEAMS WITH APPROPRIATE LOCK JOINT, SEALED WITH MASTIC SEALANT.
  - 1) USE PITTSBURGH LOCK ON FITTINGS.
- SNAPLOCK ALLOWED ON STRAIGHT DUCT JOINTS. SECURE EACH END OF JOINT WITH SHEET METAL 2) SCREW.

CONSTRUCT T'S, BENDS, AND ELBOWS WITH MINIMUM RADIUS 1-1/2 TIMES CENTERLINE DUCT WIDTH. WHERE NOT POSSIBLE AND WHERE RECTANGULAR ELBOWS ARE USED, PROVIDE TURNING VANES.

- 1) HARPER DOUBLE WALL TURNING VANES FABRICATED FROM SAME MATERIAL AS DUCT. 2) TAB SPACING IN CONFORMANCE WITH SMACNA STANDARD. USE ALL TABS.

INCREASE DUCT SIZES GRADUALLY, NOT EXCEEDING 15 DEGREES DIVERGENCE WHEREVER POSSIBLE; MAXIMUM F. 30 DEGREES DIVERGENCE UPSTREAM OF EQUIPMENT AND 45 DEGREES CONVERGENCE DOWNSTREAM.

G. ALL DUCTWORK SHALL BE MINIMALLY SEALED AS DEFINED FOR A CLASS C SEALANT CLASS, ACCORDING TO SMACNA DUCT CONSTRUCTION STANDARDS, REGARDLESS OF ACTUAL PRESSURE CLASS. CLASS A AND CLASS B SEALANT CLASSES STILL APPLY TO APPLICABLE PRESSURE CLASSES. 3. DUCT ACCESS DOORS

A. FABRICATE IN ACCORDANCE WITH SMACNA HVAC DUCT CONSTRUCTION STANDARDS - METAL AND FLEXIBLE, AND AS INDICATED ON DRAWINGS.


- B. FABRICATION: RIGID AND CLOSE FITTING OF GALVANIZED STEEL WITH SEALING GASKETS AND QUICK FASTENING LOCKING DEVICES. FOR INSULATED DUCTWORK, FURNISH MINIMUM 1 INCH THICK INSULATION WITH SHEET METAL COVER.
  - LESS THAN 12 INCHES SQUARE, SECURE WITH SASH LOCKS.
  - 2) UP TO 18 INCHES SQUARE: FURNISH TWO HINGES AND TWO SASH LOCKS.

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### DUVAL COUNTY COURTHOUSE

ROOF REMEDIATION, EXTERIOR WINDOWS, & ELECTRICAL

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**REVISION HISTORY** 

 Issued for Bid June 19, 2025

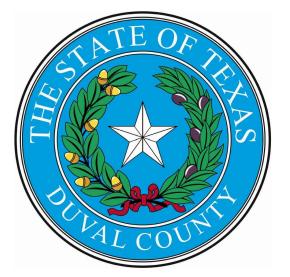SEAL



June 19, 2025

Architexas No. 2433

Date 06/19/2025

**Sheet Name** MECHANICAL AND PLUMBING COVER SHEET AND SPECIFICATIONS Sheet Number




DUCTS AND DUCT ACCESSORIES (CONT.)	PLUMBING FIXTURES (CONT.)	PLUMBING FIXTURES (CONT.)
4. DYNAMIC FIRE DAMPERS	B. CHROME-PLATED 17-GAUGE BRASS TUBING P-TRAP WITH CLEAN-OUT. PROVIDE WITH BRASS QUARTER BEND.	
A. MANUFACTURERS: POTTORFF, RUSKIN	BRASS CLEAN-OUT PLUG, FIBER CLEAN-OUT WASHER, RUBBER WASHERS, DIE CAST NUTS.	<ul> <li>ADJUSTING:</li> <li>A. ADJUSTING STOPS OR VALVES FOR INTENDED WATER FLOW RATE TO FIXTURES WITHOUT SPLASHING, NOISE, OR</li> </ul>
<ol> <li>ROUND/OVAL DUCTS AT WALL PENETRATION - MODEL VFD-10D-B.</li> <li>B. FABRICATE IN ACCORDANCE WITH NFPA 90A AND UL 555.</li> </ol>	C. SIZE: 1) LAVATORY: 1-1/4 INCH X 1-1/4 INCH.	OVERFLOW.
C. FIRE RESISTANCE: 1-1/2 HOURS.	4. OFFSET WASTE WITH PERFORATED OPEN STRAINER:	14. CLEANING. A. CLEAN PLUMBING FIXTURES AND EQUIPMENT.
D. DYNAMIC CLOSURE RATING: DAMPERS CLASSIFIED FOR DYNAMIC CLOSURE TO 2000 FPM AND 4 INCHES WG STATIC PRESSURE.	A. MANUFACTURERS: BRASS CRAFT PART NUMBER 0702, MCGUIRE PART NUMBER 155WC	15. PROTECTION OF FINISHED WORK:
E. CONSTRUCTION:	B. POLISHED CHROME CAST BRASS OFFSET LAVATORY STRAINER, ADA COMPLIANT, CAST BRASS SOLID TOP OPEN GRID STRAINER, CAST BRASS ELBOW AND 1-1/4 INCH 17 GAUGE OFFSET TAILPIECE.	A. DO NOT PERMIT USE OF FIXTURES.
1) INTEGRAL SLEEVE FRAME: MINIMUM 20 GAGE ROLL FORMED GALVANIZED STEEL. LENGTH: 12 INCHES.	5. <u>P-1</u> - WATER CLOSET, FLOOR MOUNTED, MANUAL FLUSH VALVE - TAS	
2) BLADES: a. STYLE: CURTAIN TYPE.	A. BOWL: 1) MANUFACTURERS: AMERICAN STANDARD MODEL 3043.001	
<ul> <li>b. ACTION: SPRING OR GRAVITY CLOSURE UPON FUSIBLE LINK RELEASE.</li> </ul>	2) ASME A112.19.2M; FLOOR MOUNTED, SIPHON JET 16-1/2 INCH BOWL HEIGHT, TAS ACCESSIBLE, VITREOUS	
c. MATERIAL: MINIMUM 24 GAGE ROLL FORMED, GALVANIZED STEEL.	CHINA CLOSET BOWL, WITH ELONGATED RIM, 1-1/2 INCH TOP SPUD, CHINA BOLT CAPS, MINIMUM 2 INCH PASSAGEWAY.	
<ul> <li>CLOSURE SPRINGS: TYPE 301 STAINLESS STEEL, CONSTANT FORCE TYPE, IF REQUIRED.</li> <li>FUSIBLE LINK RELEASE TEMPERATURE: 165 DEGREES F.</li> </ul>	B. MANUAL OPERATED FLUSH VALVE:	
G. MOUNTING: VERTICAL OR HORIZONTAL AS INDICATED ON DRAWINGS.	<ol> <li>MANUFACTURER: AMERICAN STANDARD MODEL 6147121.002</li> <li>ASME A112.19.2; EXPOSED CHROME PLATED, DIAPHRAGM TYPE, INTEGRAL SCREWDRIVER STOP AND</li> </ol>	
H. DUCT TRANSITION CONNECTION, DAMPER STYLE:	VACUUM BREAKER, ADJUSTABLE TAILPIECE, VANDAL RESISTANT STOP CAP WITH SET SCREW, SWEAT SOLDER ADAPTER WITH COVER TUBE AND CAST SET SCREW WALL FLANGE, MAXIMUM 1.28 GALLON FLUSH	
<ol> <li>BR STYLE - ROUND CONNECTION.</li> <li>FLEXIBLE DUCT CONNECTIONS:</li> </ol>	VOLUME, 11-1/2 INCH RISER.	
A. FABRICATE IN ACCORDANCE WITH SMACNA HVAC DUCT CONSTRUCTION STANDARDS - METAL AND FLEXIBLE, AND	C. SEAT: 1) MANUFACTURER: BEMIS MODEL 1955 SSC	
AS INDICATED ON DRAWINGS. B. CONNECTOR: FABRIC CRIMPED INTO METAL EDGING STRIP.	2) SOLID WHITE PLASTIC, OPEN FRONT, EXTENDED BACK, SELF-SUSTAINING HINGE, AND BRASS BOLTS.	
1) FABRIC: UL LISTED FIRE-RETARDANT NEOPRENE COATED WOVEN GLASS FIBER FABRIC CONFORMING TO	6. <u>P-2</u> - URINAL, WALL HUNG, MANUAL FLUSH VALVE - TAS	
NFPA 90A, MINIMUM DENSITY 30 OZ PER SQ YD. 2) NET FABRIC WIDTH: APPROXIMATELY 6 INCHES WIDE.	A. URINAL: 1) MANUFACTURERS: AMERICAN STANDARD 6042.001EC	
<ul><li>3) METAL: 3 INCH WIDE, 24 GAGE GALVANIZED STEEL.</li></ul>	2) ASME A112.19.2; VITREOUS CHINA, WALL HUNG WASHOUT ACTION URINAL WITH SHIELDS, 14 INCH	
6. SEALERS:	EXTENDED LIP, INTEGRAL TRAP, 3/4 INCH TOP SPUD. 3) 0.125 GALLONS PER FLUSH.	
<ul><li>A. FLEXIBLE WATER BASED ADHESIVE SEALANT DESIGNED FOR USE IN ALL PRESSURE DUCT SYSTEMS.</li><li>B. UL LISTED AND CONFORMING TO ASTM E 84.</li></ul>	4) REFER TO ARCHITECTURAL ELEVATIONS FOR MOUNTING HEIGHT.	
7. EXAMINATION:	<ul> <li>B. MANUAL OPERATED FLUSH VALVE:</li> <li>1) MANUFACTURER: AMERICAN STANDARD 6045.013.002</li> </ul>	
<ul><li>A. VERIFY SIZES OF EQUIPMENT CONNECTIONS BEFORE FABRICATING TRANSITIONS.</li><li>8. INSTALLATION:</li></ul>	2) ASME A112.19.2; EXPOSED CHROME PLATED, DIAPHRAGM TYPE, INTEGRAL SCREWDRIVER STOP AND	
A. INSTALL AND SEAL DUCTS IN ACCORDANCE WITH SMACNA HVAC DUCT CONSTRUCTION STANDARDS - METAL AND	VACUUM BREAKER, ADJUSTABLE TAILPIECE, VANDAL RESISTANT STOP CAP WITH SET SCREW, SWEAT SOLDER ADAPTER WITH COVER TUBE AND CAST SET SCREW WALL FLANGE, MAXIMUM 0.125 GALLON FLUSH	
FLEXIBLE. B. DURING CONSTRUCTION PROVIDE TEMPORARY CLOSURES OF METAL OR TAPED POLYETHYLENE ON OPEN	VOLUME, 11-1/2 INCH RISER. C. WALL MOUNTED CARRIER:	
DUCTWORK TO PREVENT CONSTRUCTION DUST FROM ENTERING DUCTWORK SYSTEM.	1) MANUFACTURERS: ZURN Z-1221	
C. USE CRIMP JOINTS WITH OR WITHOUT BEAD OR BEADED SLEEVE COUPLINGS FOR JOINING ROUND DUCT SIZES 8 INCH AND SMALLER.	2) ASME A112.6.1; CAST IRON AND STEEL FRAME WITH TUBULAR LEGS, LUGS FOR FLOOR AND WALL ATTACHMENT, THREADED FIXTURE STUDS FOR FIXTURE HANGER.	
D. USE DOUBLE NUTS AND LOCK WASHERS ON THREADED ROD SUPPORTS.	7. $\underline{P-3}$ - LAVATORY, WALL HUNG - TAS	
<ol> <li>CLEANING:</li> <li>A. CLEAN DUCT SYSTEMS WITH HIGH POWER VACUUM MACHINES. PROTECT EQUIPMENT THAT MAY BE HARMED BY</li> </ol>	A. VITREOUS CHINA WALL HUNG BASIN:	
EXCESSIVE DIRT WITH FILTERS, OR BYPASS DURING CLEANING. PROVIDE ADEQUATE ACCESS INTO DUCTWORK FOR CLEANING PURPOSES.	<ol> <li>MANUFACTURERS: AMERICAN STANDARD 9024.008EC</li> <li>ASME A112.19.2; VITREOUS CHINA WALL HUNG LAVATORY 20 INCH X 18 INCH, LEDGE-BACK, 8 INCH</li> </ol>	
10. SCHEDULES:	<ul> <li>CENTERS, RECTANGULAR BASIN WITH SPLASH LIP, REAR OVERFLOW, AND SOAP DEPRESSION.</li> <li>REFER TO ARCHITECTURAL INTERIOR ELEVATIONS FOR FIXTURE INSTALLATION HEIGHT.</li> </ul>	
<ul> <li>A. DUCTWORK MATERIAL SCHEDULE</li> <li>1) EXHAUST DUCTWORK SHALL BE GALVANIZED STEEL.</li> </ul>	B. SUPPLY FITTING:	
B. DUCTWORK PRESSURE CLASS SCHEDULE	1) MANUFACTURERS: AMERICAN STANDARD MODEL 7455.814.002	
1) EXHAUST DUCTWORK: 2 INCH WG PRESSURE CLASS.	2) ASME A112.18.1; TWO-HANDLE WIDESPREAD HANDLE FAUCET, 1.2 GPM FLOW RATE, 8" CENTERS, CERAMIC CARTRIDGES.	
AIR OUTLETS AND INLETS	<ul> <li>C. ACCESSORIES:</li> <li>1) CHROME PLATED 17 GAGE BRASS P-TRAP WITH CLEAN-OUT PLUG AND ARM WITH ESCUTCHEON.</li> </ul>	
	2) OFFSET WASTE WITH PERFORATED OPEN STRAINER.	
1. LOUVERS	3) WHEEL HANDLE <sup>1</sup> / <sub>4</sub> TURN STOPS.	
<ul> <li>A. MANUFACTURERS: POTTORFF, RUSKIN, GREENHECK</li> <li>B. TYPE: 6 INCH DEEP WITH BLADES ON 37 DEGREE SLOPE, HEAVY CHANNEL FRAME, BIRD/INSECT SCREEN WITH 1/2</li> </ul>	<ul> <li>4) FLEXIBLE SUPPLIES.</li> <li>5) TRUE-BRO HANDICAP INSULATION KIT.</li> </ul>	
INCH SQUARE MESH FOR EXHAUST AND 3/4 INCH FOR INTAKE. C. FABRICATION: 12 GAGE THICK EXTRUDED ALUMINUM. WELDED ASSEMBLY. WITH FACTORY ANODIZED FINISH.	D. WALL MOUNTED CARRIER:	
COLOR TO BE SELECTED TO BE SELECTED BY ARCHITECT.	<ol> <li>MANUFACTURER: ZURN Z1231EZ</li> <li>ASME A112.6.1; CAST IRON AND STEEL FRAME WITH TUBULAR LEGS, LUGS FOR FLOOR AND WALL</li> </ol>	
<ul> <li>D. MOUNTING: FURNISH WITH EXTERIOR ANGLE FLANGE FOR INSTALLATION.</li> <li>E. INSECT SCREEN: INSECT SCREEN WITH 1/2 INCH SQUARE MESH FOR EXHAUST AND 3/4 INCH FOR INTAKE.</li> </ul>	ATTACHMENT, THREADED STUDS FOR FIXTURE HANGER, CONCEALED ARM SUPPORTS, BEARING PLATE AND STUDS.	
<ol> <li>INTERFACE WITH OTHER PRODUCTS</li> </ol>	8. <u>P-4</u> - MOP BASIN, SQUARE TERRAZZO, 32"X32"X12"	
A. CHECK LOCATION OF OUTLETS AND INLETS AND MAKE NECESSARY ADJUSTMENTS IN POSITION TO CONFORM TO ARCHITECTURAL FEATURES, SYMMETRY, AND LIGHTING ARRANGEMENT.		
	<ol> <li>FIAT MODEL TSB3001; 32X32X12, 6" DROP FRONT.</li> <li>2 INCH WIDE SHOULDERS, STAINLESS STEEL CAPS, 3" STAINLESS STEEL CAST INTEGRAL DRAIN BODY,</li> </ol>	
PLUMBING FIXTURES	B. TRIM:	
<ol> <li>WHEEL HANDLE ¼ TURN STOPS:</li> <li>A. MANUFACTURERS: BRASS CRAFT MODEL KTCR19 C, NO SUBSTITUTIONS</li> </ol>	B. TRIM: 1) MANUFACTURERS: AMERICAN STANDARD MODEL 8354112.004	
<ul> <li>MANUFACTORERS. BRASS CRAFT MODEL RTCRT9 C, NO SUBSTITUTIONS</li> <li>B. OPERATING TEMPERATURE:</li> </ul>	2) ASME A112.18.1 EXPOSED WALL TYPE SUPPLY WITH LEVER HANDLES, SPOUT WALL BRACE, PAIL HOOK, VACUUM BREAKER, HOSE END SPOUT, STRAINERS, ECCENTRIC ADJUSTABLE INLETS, INTEGRAL LOOSE KEY	
1) 40-150 DEGREES F. INTERMITTENT TO 180 DEGREES F.	STOPS, AND ADJUSTABLE THREADED WALL FLANGES.	
C. OPERATING PRESSURE: 1) 125 PSI MAXIMUM.	<ul> <li>C. ACCESSORIES:</li> <li>1) 5 FEET OF 1/2 INCH DIAMETER PLAIN END REINFORCED RUBBER HOSE.</li> </ul>	
D. MATERIAL SPECIFICATIONS:	<ul> <li>2) HOSE CLAMP HANGER.</li> </ul>	
<ol> <li>BODY AND BRASS COMPONENTS: CHROME PLATED C36000 BRASS.</li> <li>STEM: PLATED C36000 BRASS.</li> </ol>	<ul> <li>3) MOP HANGER.</li> <li>4) MSG STAINLESS STEEL WALL GUARDS.</li> </ul>	
<ul><li>3) SEATS: PURE PTFE.</li></ul>	4) MSG STAINLESS STEEL WALL GUARDS. 9. EXAMINATION:	
4) BALL: CHROME PLATED C36000 BRASS.	A. VERIFY THAT WALLS AND FLOOR FINISHES ARE PREPARED AND READY FOR INSTALLATION OF FIXTURES.	
<ul><li>5) O-RING: NITRILE.</li><li>6) HANDLE: CHROME PLATED ZINC DIE CAST.</li></ul>	10. PREPARATION: A. ROUGH-IN FIXTURE PIPING CONNECTIONS IN ACCORDANCE WITH MINIMUM SIZES INDICATED IN FIXTURE ROUGH-IN	
7) HANDLE SCREW: ZINC PLATED STEEL.	SCHEDULE FOR PARTICULAR FIXTURES.	
<ul> <li>8) COMPRESSION SLEEVE: C36000 BRASS.</li> <li>9) FLEXIBLE SUPPLY RISERS:</li> </ul>	B. VERIFY ROUGH-IN HEIGHTS BEFORE INSTALLATION. SECURE RULING ON HEIGHTS OF TAS FIXTURES BEFORE ROUGH-IN.	
2. FLEXIBLE SUPPLY RISERS:	11. INSTALLATION:	
A. MANUFACTURERS: BRASS CRAFT SPEEDI PLUMB PLUS	<ul><li>A. INSTALL EACH FIXTURE WITH TRAP, EASILY REMOVABLE FOR SERVICING AND CLEANING.</li><li>B. PROVIDE CHROME PLATED RIGID OR FLEXIBLE SUPPLIES TO FIXTURES WITH STOPS, REDUCERS, AND</li></ul>	
<ul> <li>B. OPERATING TEMPERATURE:</li> <li>1) 40-150 DEGREES F. INTERMITTENT TO 180 DEGREES F.</li> </ul>	ESCUTCHEONS. C. INSTALL COMPONENTS LEVEL AND PLUMB.	
C. OPERATING PRESSURE:	<ul><li>D. INSTALL COMPONENTS LEVEL AND PLOMB.</li><li>D. INSTALL AND SECURE FIXTURES IN PLACE WITH WALL SUPPORTS, WALL CARRIERS AND BOLTS.</li></ul>	
1) 125 PSI MAXIMUM. D. MATERIAL SPECIFICATIONS:	E. SEAL FIXTURES TO WALL AND FLOOR SURFACES WITH SEALANT	
1) NUTS: C36000 BRASS.	F. SOLIDLY ATTACH WATER CLOSETS TO FLOOR WITH LAG SCREWS. LEAD FLASHING IS NOT INTENDED HOLD FIXTURE IN PLACE.	
2) END FITTINGS: C36000 BRASS.	G. FOR TAS ACCESSIBLE WATER CLOSETS, INSTALL FLUSH VALVE WITH HANDLE TO WIDE SIDE OF STALL	
<ol> <li>BRAIDING: POLYVINYL CHLORIDE COATED POLYESTER YARN.</li> <li>TUBING: EPDM RUBBER.</li> </ol>	12. TAS COMPLIANCE: A. OBTAIN RULING ON MOUNTING HEIGHTS OF ALL FIXTURES.	
5) WASHERS: NITRILE RUBBER.	B. INSTALL PRE-FORMED INSULATING COVERS ON ALL EXPOSED TAILPIECES, TRAPS, AND WATER SERVICE BENEATH TAS COMPLIANT SINKS, LAVATORIES, ETC.	
<ol> <li>CHROME PLATED BRASS P-TRAP:</li> <li>A. MANUFACTURERS: BRASS CRAFT, MCGUIRE, DEARBORN BRASS</li> </ol>		
, , ,		



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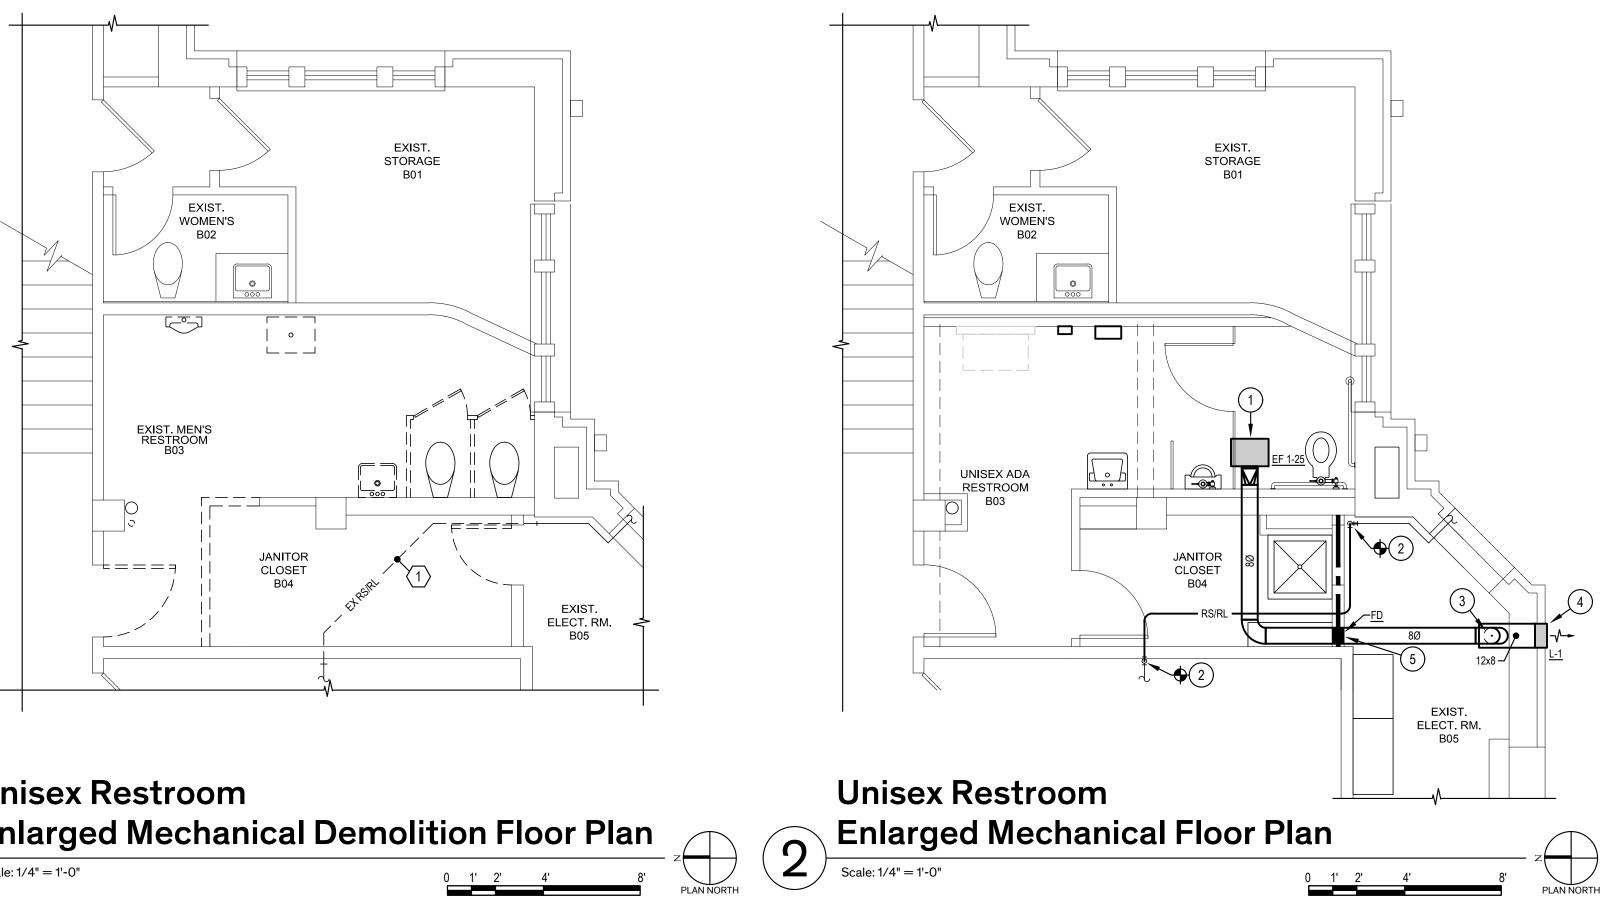
June 19, 2025


**Architexas No.** 2433

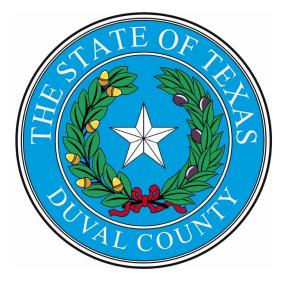Date 06/19/2025

Sheet Name MECHANICAL & PLUMBING SPECIFICATIONS





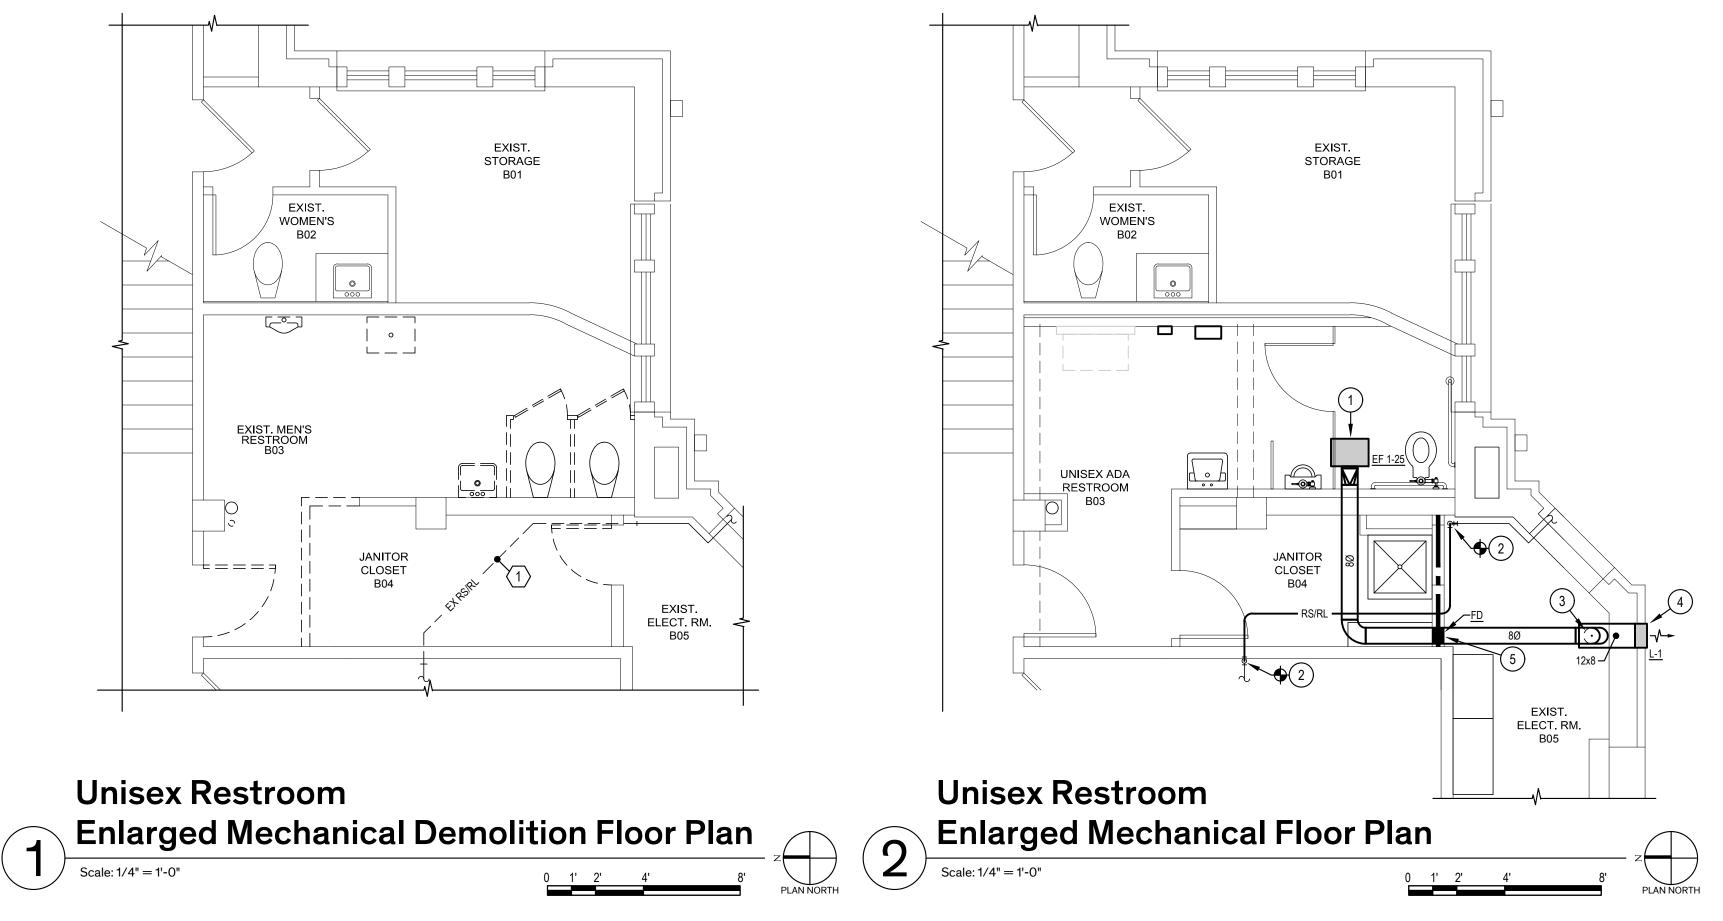

ALTERNATE NO. 2
REHABILITATE MEN'S RESTROOM AT BASEMENT
LEVEL TO ADA COMPLIANT UNISEX RESTROOM,
REFER TO SPEC. SECT. 01230-ALTERNATES

							RATED WALL LEGEND					
						MAR	MARK DESCRIPTI					
									1 HR FIRE	RATI	ED ASSEMBLY	
	LOUVER SCHEDULE											
	MARK TYPE SIZE (WxHxD) FREE AREA (FT2) FINISH FRAME EXAMPLE: POTTOR											
	L-1	EXHAUS	T 12	2x8x6	0.20	0.20		EXTERIOR FLANGE		EFD-637		
	NOTES:	1. COLO	R TO BE S	SELECTED	BY ARCHITE	CT.						
		2. PROV	IDE LOUV	ER WITH II	NSECT SCRE	EN.						
FAN S	CHEDUL	.E										
MARK	CFM	SP	WATTS	RPM	TYPE	DRIVE	ELECTR	RICAL	MAX. SONE	S	EXAMPLE: COOK	
EF 1-25	200	0.4	29	1241	CEILING	DIREC	T 115/1/	60	2.5		GCVF-500	
NOTES:	1. FAN SE	LECTED A	Γ ELEVATI	ON OF 300	FEET.							
	2. PROVID	DE FAN WIT	H FACTO	RY WIRED	DISCONNEC	T AND SP	EED CONTRC	LLER.				
	3. PROVIE	DE FAN WIT	H WHITE	ALUMINUM	I GRILLE.							

### GENERAL NOTES:

- COORDINATE DEMOLITION WORK, NEW DUCTWORK, AND NEW EQUIPMENT WITH ARCHITECTURAL, STRUCTURAL, PLUMBING, AND ELECTRICAL SYSTEMS.
- 2. FIELD MEASURE CLEARANCES REQUIRED FOR DUCTWORK INSTALLATION PRIOR TO FABRICATION.
- NEW REFRIGERANT PIPING SHALL BE TYPE ACR HARD DRAWN COPPER AND FITTINGS SHALL BE LONG RADIUS TYPE.
- 4. REFRIGERANT SUCTION PIPING SHALL BE INSULATED USING 3/4 INCH ARMAFLEX CLOSED CELL INSULATION.
- 5. GENERALLY, INSTALL MECHANICAL DUCTWORK AND EQUIPMENT ABOVE DOMESTIC WATER PIPING.
- 6. THERE SHALL NOT BE ANY EXPOSED MEP DEVICES OR DISTRIBUTION LINES IN RESTROOM B03, CONCEAL ABOVE SUSPENDED CEILING AND WALL FURR OUTS, REFER TO ARCHITECTURAL DRAWINGS.

### DEMOLITION KEYED NOTES:

REMOVE EXISTING REFRIGERANT PIPING SHOWN DASHED. REFER TO NEW WORK ON THIS SHEET.

### **KEYED NOTES:**


- 1 SUSPEND CEILING MOUNTED FAN FROM STRUCTURE USING THREADED ROD AND NEOPRENE ISOLATORS. CONNECT DUCTWORK TO FAN USING FLEXIBLE CONNECTION.
- 2 CONNECT NEW REFRIGERANT PIPING TO EXISTING AND ROUTE EXPOSED ALONG WALL TO OVERHEAD SPACE. FIELD VERIFY EXISTING PIPE SIZES.
- (3) EXHAUST DUCTWORK DOWN ALONG WALL TO LOUVER. MAINTAIN REQUIRED NEC CLEARANCE IN FRONT OF NEW/EXISTING ELECTRICAL PANELS.
- (4) INSTALL NEW EXHAUST LOUVER IN EXTERIOR WALL ABOVE AREA WAY STEPS. INSTALL LOUVER AS LOW AS POSSIBLE. COORDINATE LOCATION WITH ARCHITECT. REFER TO ARCHITECTURAL DRAWINGS FOR LINTEL INSTALLATION DETAIL.
- 5 INSTALL FIRE DAMPER IN DUCT AT WALL PENETRATION. INSTALL DUCT ACCESS DOOR IN EXISTING ELECTRICAL ROOM B05.



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Architexas No. 2433

Date 06/19/2025

Sheet Name BASEMENT ENLARGED MECHANICAL FLOOR PLANS

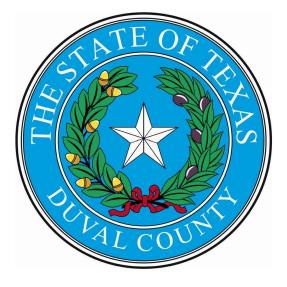Sheet Number


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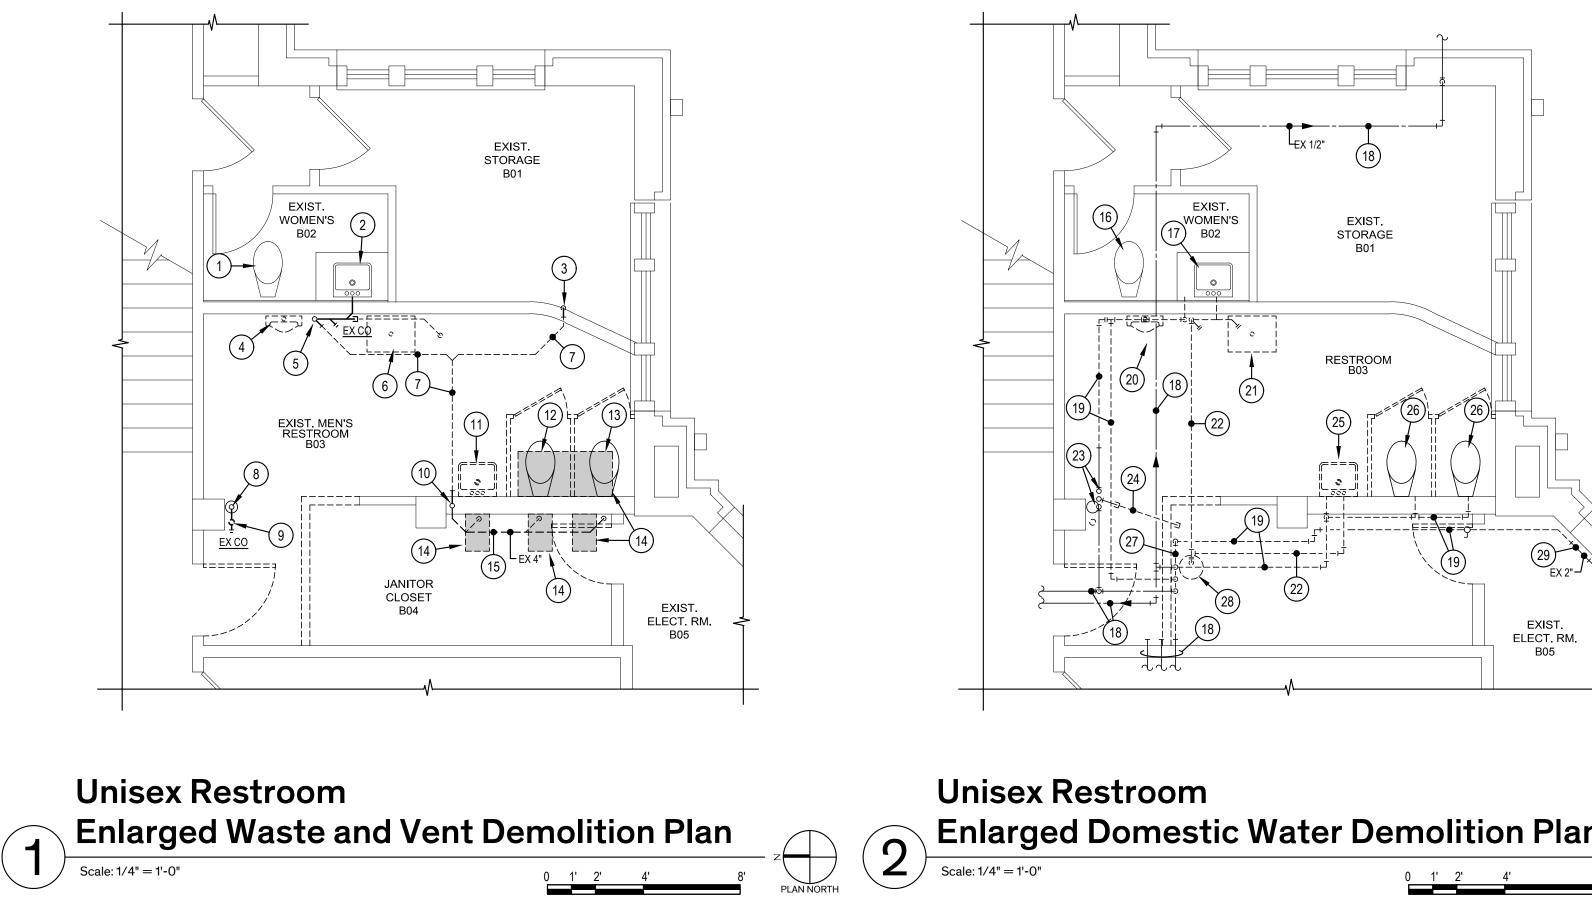
PLAN NORTH



Keyplan - Basement	






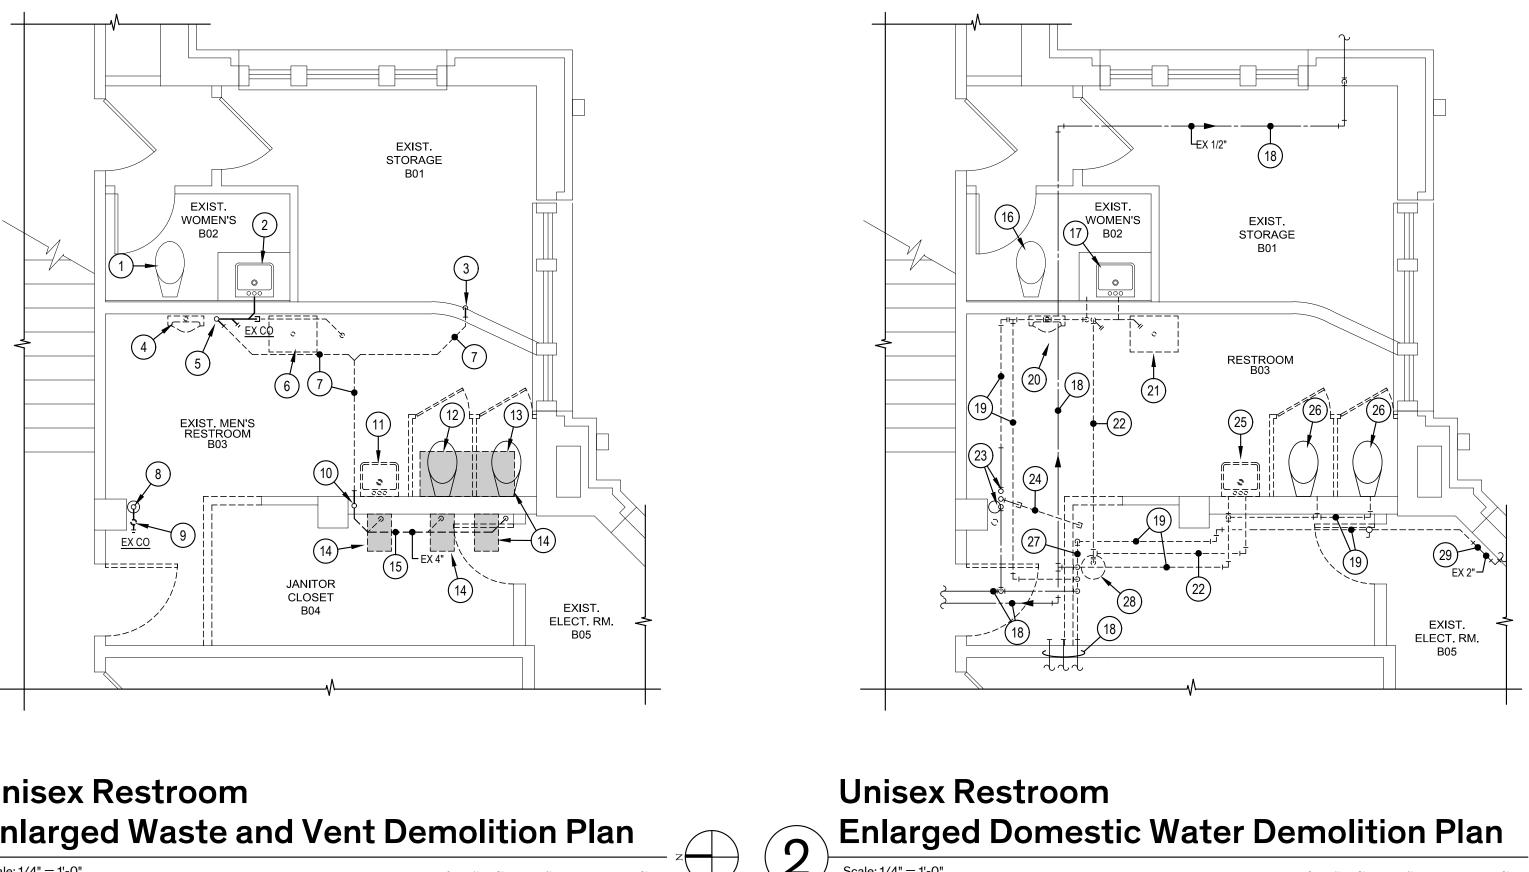



ALTERNATE NO. 2 REHABILITATE MEN'S RESTROOM AT BASEMENT LEVEL TO ADA COMPLIANT UNISEX RESTROOM, REFER TO SPEC. SECT. 01230-ALTERNATES

		GENERAL NOTES:	Archit	texas
	1.	COORDINATE DEMOLITION WORK WITH ARCHITECTURAL, STRUCTURAL, MECHANICAL, AND ELECTRICAL SYSTEMS.	Austin   Dallas San Antonio	2900 S. Congress Ave. Suite 200
	2.	FIELD VERIFY EXACT LOCATION, SIZE, AND ELEVATION OF EXISTING UTILITIES PRIOR TO COMMENCING WORK.	www.architexas.com	Austin, Texas 78704 p 512.444.4220
	3.	CAMERA ALL EXISTING UNDERFLOOR SEWER/WASTE PIPING SERVING RESTROOM B03 TO DETERMINE PIPING CONDITION. NOTIFY THE ARCHITECT OF ANY PIPING DETERIORATION OR FAILURES.		
	4.	THE EXACT ROUTING OF EXISTING UNDERFLOOR UTILITIES IS UNKNOWN. CONTRACTOR SHALL USE UTILITY CAMERA TO DETERMINE EXACT ROUTING OF ALL EXISTING UNDERGROUND UTILITIES PRIOR TO CUTTING ANY SLAB. MODIFY LAYOUT OF NEW UTILITIES AS REQUIRED FOR CONNECTIONS TO EXISTING. PROVIDE AS-BUILT DRAWINGS OF EXISTING UNDERFLOOR UTILITIES TO BUILDING OWNER AT COMPLETION OF PROJECT.		
	5.	ESTABLISH GRADES AND CONNECTION POINTS TO EXISTING UTILITIES PRIOR TO COMMENCING WORK.		BROWN
	6.	REMOVE HANGERS AND SUPPORTS SERVING PIPING TO BE REMOVED. DO NOT ABANDON HANGERS IN PLACE.		CONSULTING ENGINEERS INC. uite 110+Amarillo, Texas 79109
	7.	IN ADDITION TO AREAS SHOWN SPECIFICALLY TO BE REMOVED, THE CONTRACTOR SHALL SAWCUT, REMOVE, AND REPLACE EXISTING SLAB AS REQUIRED TO PERFORM NEW WORK. REFER TO SHEET P201 FOR NEW WORK.		tered Engineering Firm F-683
		KEYED NOTES:		
	(1)	EXISTING WATER CLOSET AND ASSOCIATED SEWER AND VENT PIPING TO REMAIN.		
	$\left  \begin{array}{c} 2 \\ 3 \end{array} \right $	EXISTING LAVATORY AND ASSOCIATED WASTE AND VENT PIPING TO REMAIN. EXISTING VENT PIPING WITHIN WALL TO REMAIN.		
	4	REMOVE EXISTING URINAL AND CARRIER. REMOVE ASSOCIATED WASTE PIPING DOWN TO BELOW SLAB AND CAP.		
	(5)	EXISTING VENT PIPING UP FROM BELOW SLAB TO OVERHEAD SPACE TO REMAIN.		
	6	REMOVE EXISTING SINK. REMOVE ASSOCIATED WASTE PIPING SHOWN DASHED AND CAP.		
	7	REMOVE EXISTING VENT PIPING SHOWN DASHED. REFER TO NEW WORK ON SHEET P201.		
	8	EXISTING 4 INCH SEWER PIPING DOWN THRU FIRST FLOOR TO REMAIN.	TI	OF
	(9)	REMOVE ABANDONED P-TRAP AND 2 INCH WASTE PIPING DOWN TO EXISTING CLEANOUT AT FLOOR LEVEL AND CAP. EXISTING CLEANOUT TO REMAIN.		
			E	
z	(11)	REMOVE EXISTING LAVATORY AND CARRIER. REMOVE ASSOCIATED WASTE AND VENT PIPING BACK TO MAINS AND CAP.		
PLAN NORTH	(12)	REMOVE EXISTING WATER CLOSET. REMOVE ASSOCIATED SEWER AND VENT PIPING DOWN IN WALL TO BELOW SLAB AND CAP.		
	(13)	REMOVE EXISTING WATER CLOSET. MODIFY ASSOCIATED SEWER AND VENT PIPING AS REQUIRED FOR INSTALLATION OF NEW FIXTURE. REFER TO NEW WORK ON SHEET P201.	VAL .	COUL
	14	SAWCUT AND REMOVE EXISTING SLAB SHOWN SHADED FOR INSTALLATION OF NEW UNDERFLOOR SEWER/WASTE PIPING. REFER TO NEW WORK ON SHEET P201.	DUVAL COL	
	(15)	EXISTING VENT PIPING WITHIN JANITOR CLOSET TO REMAIN.	COURTHOL ROOF REMEDIATION	
	(16)	EXISTING WATER CLOSET TO REMAIN. REMOVE ALL ASSOCIATED COLD WATER PIPING.	WINDOWS, & ELECT	
	$\left  \right\rangle$	EXISTING LAVATORY TO REMAIN. REMOVE ALL ASSOCIATED COLD AND HOT WATER PIPING.		400 E. Gravis Ave.
	(18) (19)	EXISTING GALVANIZED COLD WATER PIPING OVERHEAD TO REMAIN. REMOVE EXISTING COLD WATER PIPING SHOWN DASHED.		San Diego, Texas 78384
	(10)	REMOVE EXISTING URINAL. REMOVE FLUSH VALVE AND ALL ASSOCIATED COLD WATER		
	(21)	PIPING. REMOVE EXISTING SINK. REMOVE ALL ASSOCIATED COLD AND HOT WATER PIPING.		
	(21)	REMOVE EXISTING HOT WATER PIPING SHOWN DASHED.		
	23	EXISTING GALVANIZED COLD WATER PIPING UP THRU FIRST FLOOR TO REMAIN.	The Contractor shall ve for all dimensions. DO N Any errors or omissions	NOT scale the drawing.
	24	REMOVE ABANDONED GALVANIZED WATER PIPING SHOWN DASHED AND CAP IN OVERHEAD SPACE.	Architexas without dela designs and drawings a Architexas. Reproducti	
	(25)	REMOVE EXISTING LAVATORY. REMOVE ALL ASSOCIATED COLD AND HOT WATER PIPING.	other than that authoriz forbidden.	
	26	REMOVE EXISTING WATER CLOSET. REMOVE ALL ASSOCIATED COLD WATER PIPING.		
	27	REMOVE EXISTING COLD WATER HEADER AND ASSOCIATED PIPING SHOWN DASHED.	REVISION HISTOR 1. Issued for Bid	June 19, 2025
	(28)	TEMPORARILY REMOVE EXISTING WATER HEATER AND SALVAGE FOR REUSE. REMOVE ALL ASSOCIATED PIPING. REFER TO SHEET P201.		
	29	EXISTING 2 INCH GALVANIZED COLD WATER MAIN TO REMAIN.		
			SEAL	
			STATE.	OF TEL
			TRAVIS	P. BROWN
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				NAL EL
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		Keyplan - Basement	BASEMENT I PLUMBING D PLA	EMOLITION
	-		Sheet Number	

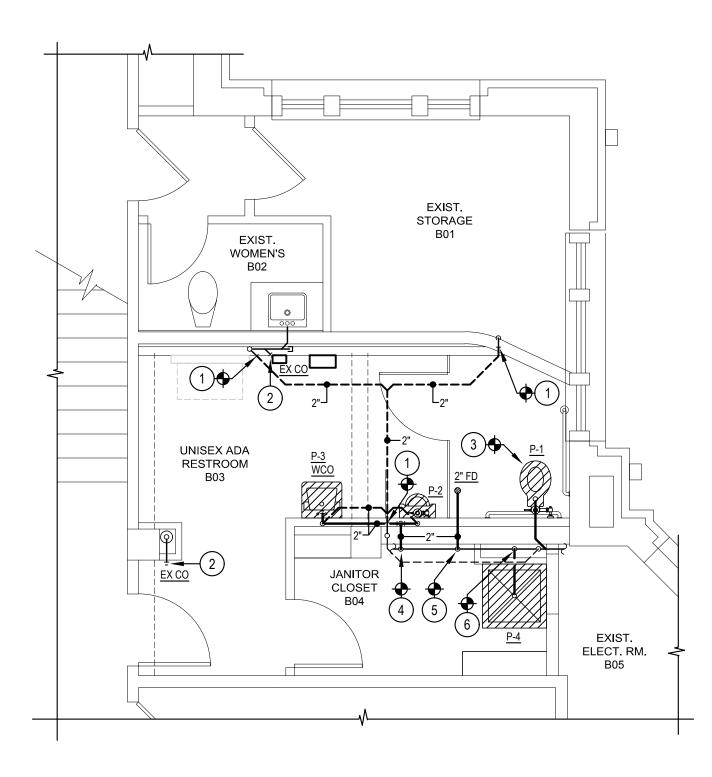




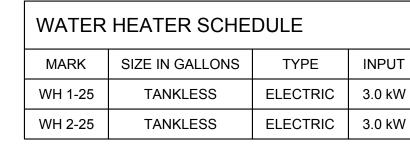

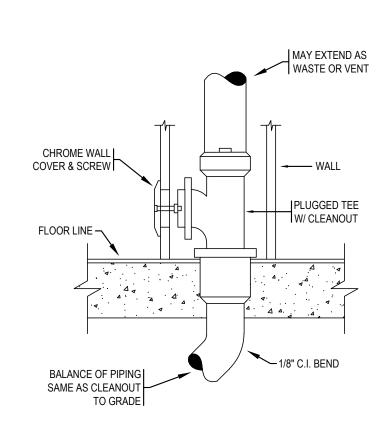


WALL CLEANOUT DETAIL NO SCALE

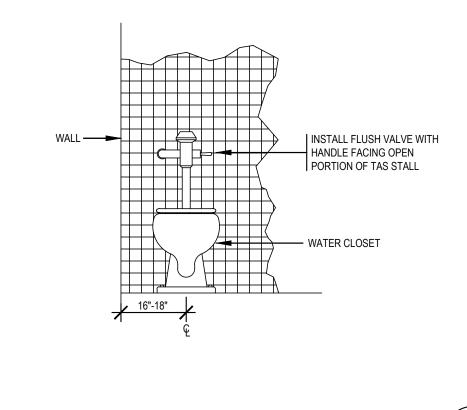

FLOOR MOUNT WATER CLOSET INSTALLATION - TAS NO SCALE

3

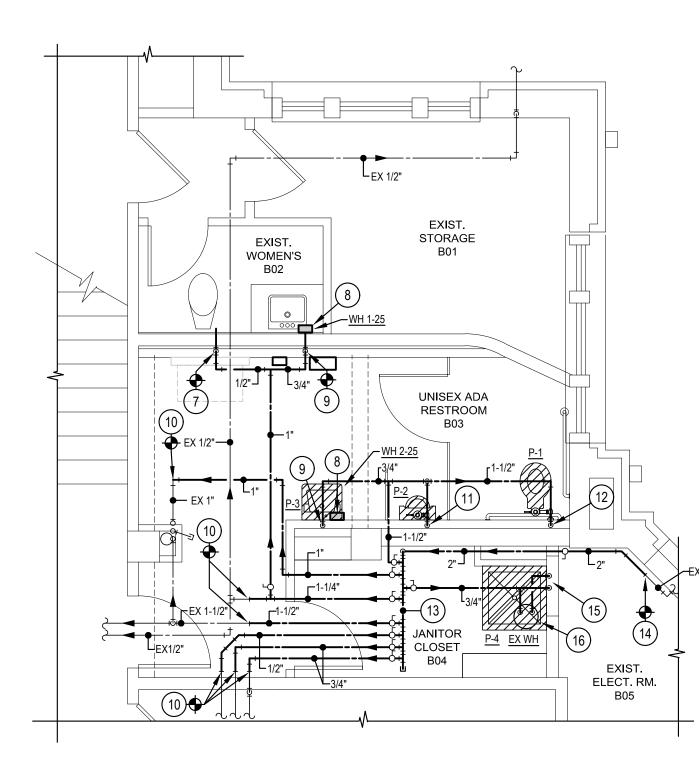

**Unisex Restroom Enlarged Domestic Water Floor Plan**  $(\mathbf{2})$ 

CONNECTIONS


ALTERNATE NO. 2 REHABILITATE MEN'S RESTROOM AT BASEMENT LEVEL TO ADA COMPLIANT UNISEX RESTROOM, REFER TO SPEC. SECT. 01230-ALTERNATES

0 1' 2' 4'

### PLUMBING FIXTURE CONNECTION SCHEDULE

Scale: 1/4" = 1'-0"

							CONF	NECTIONS	
			MARK	FIXTURE		CW	HW	WASTE	VE
			2" FD	2 INCH FLOOR DRAIN, ROUND STRAINER, TRAF	P SEAL			2	
			P-1	WATER CLOSET, FLOOR MOUNTED, MANUAL F	LUSH VALVE - TAS	1-1/2		4	2
-	ELECTRICAL	EXAMPLE: EEMAX	P-2	URINAL, WALL HUNG, MANUAL FLUSH VALVE -	TAS	3/4		2	2
1	208/1/60	FLOWCO, SPEX3208	P-3	LAVATORY, WALL HUNG - TAS		1/2	1/2	2	2
/	208/1/60	FLOWCO, SPEX3208	P-4	MOP BASIN, SQUARE TERRAZZO, 32"x32"x12"		1/2	1/2	3	2
						M BA	P-WM	TO MOP BASIN - ZURN MODEL ZW1 VALVE AND SET RGE TO 110° F.	070XL
	-(4)	NO SCALE	SVVALER	R HEATER PIPING DETAIL (5)	WALL MOUNTED WATER	HEATE		UETAIL ز	—(

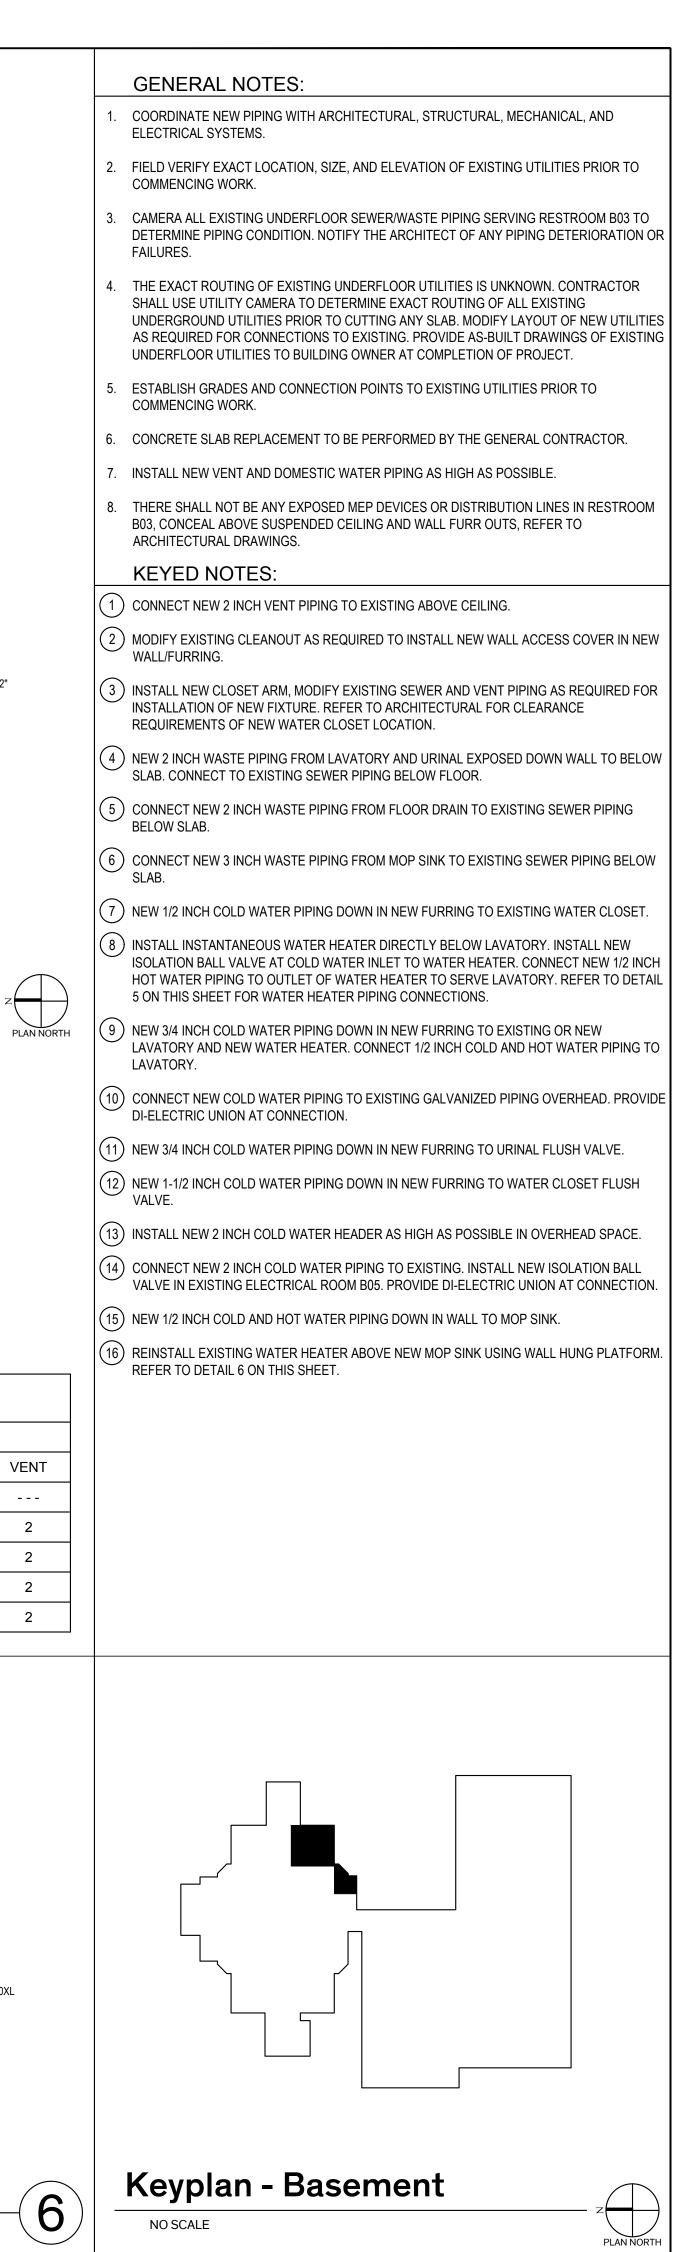

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**Sheet Name** BASEMENT ENLARGED PLUMBING PLANS




ABBR	EVIATIONS	ABBR	EVIATIONS (CONT.)	
A,AMPS	AMPERES	FIXT	FIXTURE	
AC	ALTERNATING CURRENT	FLA	FULL LOAD AMPERES	
AF	AMPERES-FUSE RATING, AMPERES-FRAME RATING	FLEX	FLEXIBLE	
AFF	ABOVE FINISHED FLOOR	FLOUR	FLOURESCENT	
AIC	AMPERES INTERRUPTING CAPACITY (SYMMETRIC)	FT	FEET	
ARCH	ARCHITECTURAL			
AT	AMPERES-TRIP RATING	GA	GAUGE	
ATS	AUTOMATIC TRANSFER SWITCH	GALV	GALVANIZED	
AUTO	AUTOMATIC	GFI	GROUND FAULT INTERRUPTER	
AWG	AMERICAN WIRE GUAGE	GFCI	GROUND FAULT CIRCUIT INTERRUPTER	
		GND	GROUND	
BKR	BREAKER			
BLDG	BUILDING	н	HEIGHT	
		HID	HIGH INTENSITY DISCHARGE	
С	CONDUIT			
C/B	CIRCUIT BREAKER	ID	INSIDE DIAMETER	
CKT	CIRCUIT	IMC	INTERMEDIATE METAL CONDUIT	
CLG	CEILING	IN	INCH(ES)	
CU	COPPER			
		JB	JUNCTION BOX	
DIA	DIAMETER			
DISC	DISCONNECT	KCMIL	THOUSAND CIRCULAR MILLS	
	DOUBLE POLE	KV	KILOVOLT	
DP		KVA	KILOVOLT AMPERE	
DPDT	DOUBLE POLE DOUBLE THROW	KVAR	KILOVOLT AMPERE REACTIVE	
DWG	DRAWING	KW	KILOWATT	
		КМН	KILOWATT HOUR	
EC	ELECTRICAL CONTRACTOR			
ELEC	ELECTRIC(AL)	L	LENGTH	
EMT	ELECTRICAL METALLIC TUBING	LA	LIGHTNING ARRESTOR	
ENCL	ENCLOSURE	LT(G)	LIGHT(ING)	
EQUIP	EQUIPMENT	LV	LOW VOLTAGE	
EXF	EXHAUST FAN	LV		


ABBR	EVIATIONS (CONT.)	ABBR	EVIATIONS (CONT.)	MISCELLANEOUS
M	MOTOR	REC	RECEPTACLE	1P ONE POLE
mA	MILLIAMPERES	RGS	RIGID GALVANIZED STEEL	2P TWO POLE
m	METER	RM	ROOM	3P THREE POLE
MAX	MAXIMUM			Ø PHASE
MECH	MECHANICAL	SC	SHORT CIRCUIT	2Ø TWO PHASE
MH	MANHOLE, MOUNTING HEIGHT, METAL HALIDE	SEC	SECONDARY	3Ø THREE PHASE
MIN	MINIMUM	SPDT	SINGLE POLE DOUBLE THROW	
MISC	MISCELLANEOUS	SPEC	SPECIFICATIONS	SITE SYMBOLS
nm	MILLIMETER	SPST	SINGLE POLE SINGLE THROW	OTL OTMBOLO
MTD	MOUNTED	SS	STAINLESS STEEL	
ITG	MOUNTING	STD	STANDARD	E POWER MANHOLE.
		SW	SWITCH	T TELECOM MANHOLE.
N	NEUTRAL	SYM	SYMMETRICAL	S SIGNAL MANHOLE.
NA	NOT APPLICABLE			DUCTBANK SECTION KEY NOTE. DIRECTION OF FLAG INDICATES
NC	NORMALLY CLOSED	TEL	TELEPHONE	$A \coprod A (1) DUCTBANK SECTION KEY NOTE. DIRECTION OF FLAG INDICATES DIRECTION OF SECTION VIEWPOINT.$
NEC	NATIONAL ELECTRICAL CODE	ТТВ	TELECOMMUNICATION TERMINAL BOARD	
NO	NORMALLY OPEN	TV	TELEVISION	
TS	NOT TO SCALE	ТҮР	TYPICAL	DETAIL NUMBER SECTION NU
OC	ON CENTER	UL	UNDERWRITERS LABORATORIES	$\sum_{1}$
OD	OUTSIDE DIAMETER			
OFE		UON	UNLESS OTHERWISE NOTED	E001
	OVERLOAD			
OL	OVERLOAD	V	VOLT, VOLTAGE	DRAWING NUMBER
		VA	VOLT AMPERES	WHERE DETAIL IS DRAWN WHERE SEC
PB	PUSH BUTTON			DETAIL INDICATION
PF	POWER FACTOR	W	WIDTH, WATTS	
PH	PHASE	W/	WITH	
PNL	PANEL	W/O	WITHOUT	
PRI	PRIMARY			
PVC	POLY-VINYL CHLORIDE	XFMR	TRANSFORMER	

### **LEGEND**

\$	SPST WALL SWITCH, 20A, 120V.
\$DS	WALL MOUNTED DIGITAL WALL SWITCH EQUAL TO A WATTSTOPPER LMSW-100. REFER TO CORRESPONDING ROOM/AREA DIGITAL OCCUPANCY SENSOR WIRING DIAGRAM FOR DETAILS.
©	CEILING MOUNTED PASSIVE INFRARED DIGITAL OCCUPANCY SENSOR EQUAL TO A WATTSTOPPER LMPC-100. REFER TO CORRESPONDING ROOM/AREA DIGITAL OCCUPANCY SENSOR WIRING DIAGRAM FOR DETAILS.
RC	DIGITAL ON/OFF ROOM CONTROLLER MOUNTED ABOVE CEILING EQUAL TO A WATTSTOPPER LMRC-100. REFER TO CORRESPONDING ROOM/AREA DIGITAL OCCUPANCY SENSOR WIRING DIAGRAM FOR DETAILS.
Φ	SIMPLEX RECEPTACLE. TYPE AS NOTED.
	BRANCH CIRCUIT DESIGNATION. IF NO CROSS MARKS ARE SHOWN, CIRCUIT CONTAINS TWO CURRENT CARRYING CONDUCTORS AND ONE GROUNDING CONDUCTOR. IF MORE THAN TWO CURRENT CARRYING CONDUCTORS ARE REQUIRED, CROSS LINES INDICATE THE FOLLOWING: SHORT CROSS LINE INDICATES NEUTRAL CONDUCTOR, LONG CROSS LINE INDICATES HOT OR SWITCHED CONDUCTOR, LONG CROSS LINE WITH DOT INDICATES ADDITIONAL ISOLATED GROUNDING CONDUCTOR.
B-12	ARROW WITH CIRCUIT NUMBER INDICATES HOMERUN AND PANEL CIRCUIT NUMBER.

ONE POLE
TWO POLE
THREE POLE
PHASE
TWO PHASE
THREE PHASE

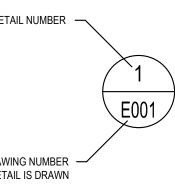

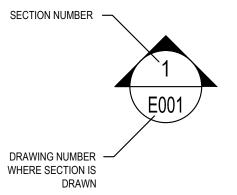

SECTION INDICATION

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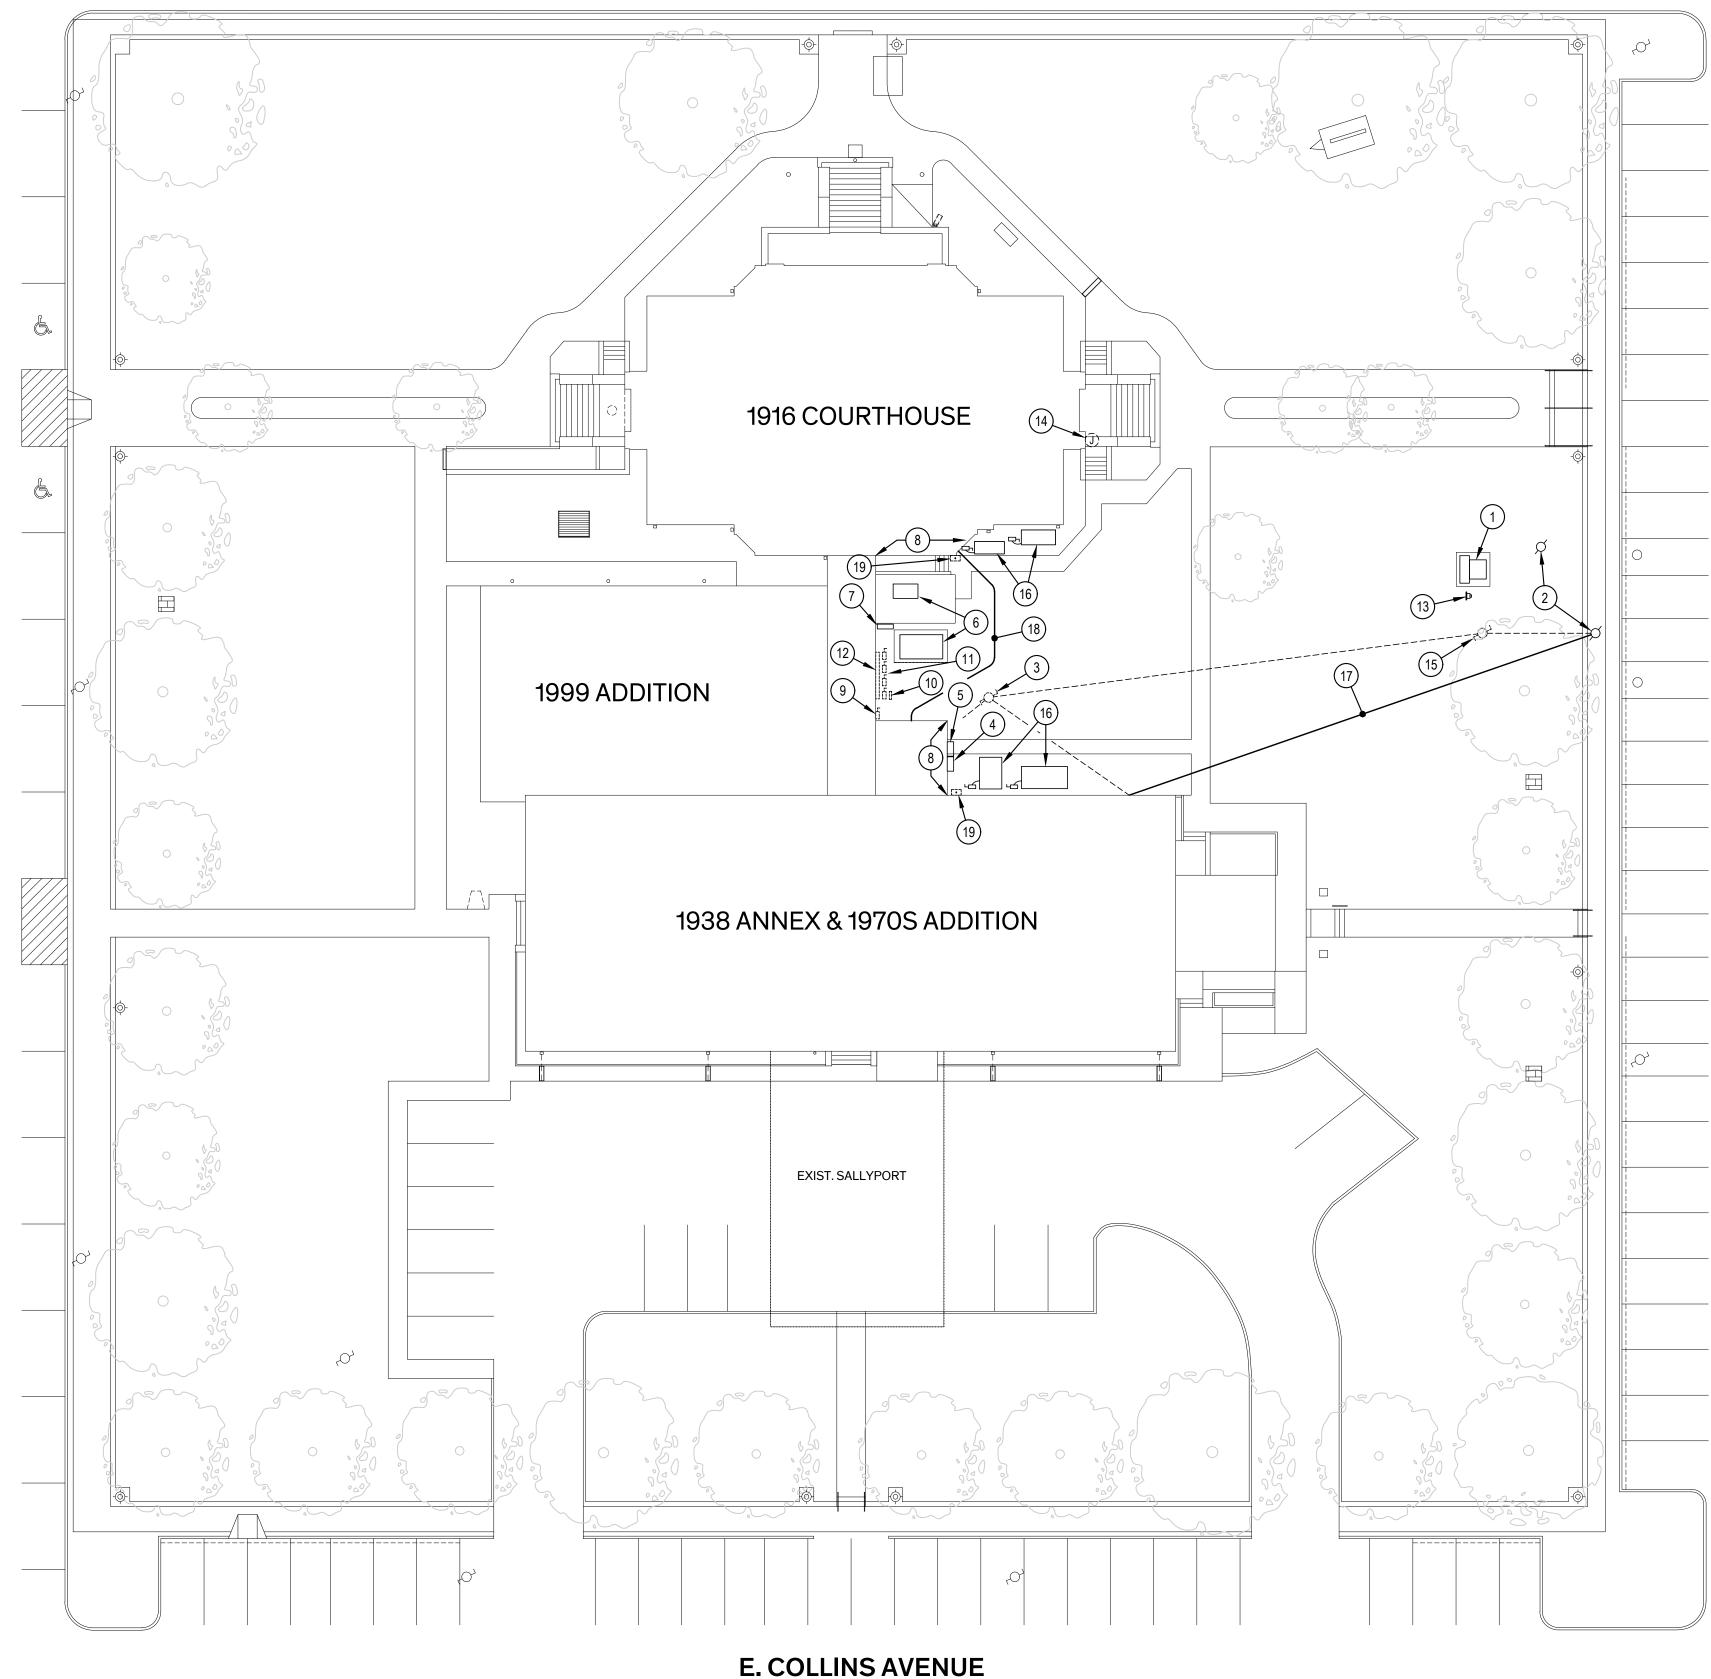
June 19, 2025

Architexas No. 2433

Date 06/19/2025

Sheet Name ELECTRICAL COVER SHEET





STREET BEXAR S

### **E. GRAVIS AVENUE** TWO-WAY STREET

TWO-WAY STREET

### GENERAL NOTES:

- 1. CONTRACTOR TO VERIFY LOCATIONS OF ALL EXISTING ELECTRICAL EQUIPMENT, DEVICES, ETC. DEVICES/EQUIPMENT MAY NOT REPRESENT ALL DEVICES/EQUIPMENT, AND CONTRACTOR SHALL BE RESPONSIBLE FOR REMOVING/RELOCATING DEVICES/EQUIPMENT NOT SHOWN AS REQUIRED FOR DEMOLITION.
- 2. CONTRACTOR TO VERIFY UNDERGROUND CONNECTIONS AND LINES PRIOR TO TRENCHING.
- **KEYED NOTES:**
- (1) EXISTING PADMOUNTED TRANSFORMER TO REMAIN.
- (2) EXISTING OVERHEAD SERVICE POLE TO REMAIN.
- 3 REMOVE AND DISCARD EXISTING ABANDONED OVERHEAD SERVICE POLE. UTILITY COMPANY TO REMOVE AND DISCARD ALL ASSOCIATED OVERHEAD POWER AND TELECOMMUNICATIONS CABLING. CONTRACTOR TO FULLY COORDINATE.
- (4) EXISTING PANEL MSB-1 TO REMAIN.
- (5) EXISTING PANEL MSB-2 TO REMAIN.
- (6) EXISTING EMERGENCY GENERATOR TO REMAIN.
- (7) EXISTING AUTOMATIC TRANSFER SWITCH TO REMAIN. REMOVE AND DISCARD EXISTING LINE WIRING AND CONDUIT TO EXISTING GUTTER. CONNECT EXISTING WIRING FEEDING PANEL EDP TO THE LINE SIDE OF THE AUTOMATIC TRANSFER SWITCH.
- (8) REMOVE AND DISCARD EXISTING ABANDONED CONDUIT ON BUILDING EXTERIOR. PATCH BRICK WALL AS REQUIRED, REFER TO ARCHITECTURAL FOR DETAILS.
- (9) REMOVE AND DISCARD EXISTING DOUBLE THROW DISCONNECT SWITCH AND ALL ASSOCIATED WIRING AND CONDUIT. CONTRACTOR TO RE-ROUTE EXISTING PANEL IN ELECTION STORAGE TO EXISTING SWITCHBOARD MSB.
- (10) REMOVE AND DISCARD EXISTING EMERGENCY PANEL, CONTRACTOR TO RE-ROUTE EXISTING LOADS ON THE JAIL SIDE THROUGH EXISTING PANEL EDP AND RE-ROUTE EXISTING LOADS ON THE COURTHOUSE SIDE THROUGH NEW EMERGENCY PANEL EB. CONTRACTOR TO EXTEND CONDUIT AND WIRING AND INSTALL JUNCTION BOXES FOR SPLICING CONNECTIONS AS NEEDED.
- (11) REMOVE AND DISCARD EXISTING DISCONNECT SWITCH(ES). RE-ROUTE EXISTING LOAD(S) THROUGH NEW EMERGENCY PANEL EDP. ONE DISCONNECT IS POWERED FROM PANEL DP1, REMOVE DISCONNECT SWITCH AND RETAIN FOR REINSTALLATION, RE-ROUTE LOAD FROM PANEL DP1 AND RELOCATE RETAINED DISCONNECT SWITCH. CONTRACTOR TO EXTEND CONDUIT AND WIRING AND INSTALL JUNCTION BOXES FOR SPLICING CONNECTIONS AS NECESSARY.
- (12) REMOVE AND DISCARD EXISTING GUTTER AND ALL ASSOCIATED WIRING. RE-ROUTE EXISTING WIRING AS INDICATED IN NOTES 10 AND 11.
- (13) EXISTING SERVICE METER TO REMAIN.
- (14) REMOVE AND DISCARD EXISTING ABANDONED CONDUIT AND JUNCTION BOX ON BUILDING EXTERIOR.
- (15) UTILITY COMPANY TO REMOVE AND DISCARD EXISTING ABANDONED OVERHEAD SERVICE POLE AND EXISTING POWER AND TELECOMMUNICATION CABLING. CONTRACTOR TO REMOVE AND DISCARD EXISTING ABANDONED SERVICE METER.
- (16) EXISTING A/C UNIT TO REMAIN.
- (17) INSTALL NEW TELECOMMUNICATIONS LINE FROM EXISTING OVERHEAD SERVICE POLE IN 1-1/2" CONDUIT DOWN POLE TO 24" BELOW GRADE TO BUILDING. COORDINATE WITH ARCHITECT FOR EXACT ROUTING DETAILS TO EXISTING IT CABINET ON SECOND FLOOR SHERIFF'S OFFICE.
- 18 BELOW GRADE FEEDER FOR NEW PANEL EB. REFER TO PARTIAL POWER RISER DIAGRAM FOR DETAILS. SAW CUT AND PATCH CONCRETE AND SEAL BRICK WALL AROUND CONDUIT AS REQUIRED.
- (19) REMOVE AND DISCARD EXISTING LIGHT FIXTURE AND ALL ASSOCIATED WIRING AND CONDUIT.

Electrical Site Plan

Scale: 1" = 20'-0"

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June 19, 2025

Architexas No. 2433

Date 06/19/2025

Sheet Name ELECTRICAL SITE PLAN



Sheet Number



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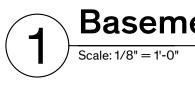
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- 1. CONTRACTOR TO VERIFY LOCATIONS OF ALL EXISTING ELECTRICAL EQUIPMENT, DEVICES, ETC. DEVICES/EQUIPMENT MAY NOT REPRESENT ALL DEVICES/EQUIPMENT, AND CONTRACTOR SHALL BE RESPONSIBLE FOR REMOVING/RELOCATING DEVICES/EQUIPMENT NOT SHOWN AS REQUIRED FOR DEMOLITION.
- 2. CONTRACTOR TO FIELD VERIFY ALL RE-ROUTED LOADS AND LABEL NEW PANEL SCHEDULE ACCORDINGLY.
- 3. ALL NEW ELECTRICAL WIRING AND CONDUIT IN PUBLIC OR SECONDARY SPACES SHALL BE CONCEALED BY SUSPENDED CEILINGS, FURR DOWNS, FURR OUTS OR WITHIN WALLS WITH THE EXCEPTION OF MECHANICAL AND ELECTRICAL SPACES UNLESS OTHERWISE NOTED. COORDINATE WITH ARCHITECT IF NOT POSSIBLE. DO NOT RUN CONDUIT/WIRING ON OUTSIDE OF BUILDING. KEYED NOTES:
- 1 EXISTING MAIN SWITCHBOARD MSB TO REMAIN. CONTRACTOR TO LABEL EACH OF THE SWITCHBOARD BREAKERS WITH THE ASSOCIATED LOAD.
- 2 EXISTING EMERGENCY PANEL TO REMAIN. CONTRACTOR TO PROVIDE A NEW NAMEPLATE AND LABEL PANEL EA.
- (3) EXISTING AUTOMATIC TRANSFER SWITCH TO REMAIN.
- (4) REMOVE AND DISCARD EXISTING DISCONNECT SWITCH. REMOVE AND DISCARD EXISTING ABANDONED CONDUIT AND WIRING. EXISTING WIRING AND CONDUIT TO BE INTERCEPTED TO CONNECT EXISTING LOADS TO NEW PANEL A25. ALL EXCESS CONDUIT AND WIRING TO BE REMOVED. CONTRACTOR TO RE-ROUTE EXISTING LOADS TO NEW PANEL A25 AND FIELD VERIFY EXACT LOADS RE-ROUTED TO NEW PANEL A25.
- (5) REMOVE AND DISCARD EXISTING PANEL. REMOVE AND DISCARD EXISTING ABANDONED CONDUIT AND WIRING. EXISTING WIRING AND CONDUIT TO BE INTERCEPTED TO CONNECT EXISTING LOADS TO NEW PANEL A25. ALL EXCESS CONDUIT AND WIRING TO BE REMOVED. CONTRACTOR TO RE-ROUTE EXISTING LOADS TO NEW PANEL A25.
- 6 EXISTING ELECTION STORAGE PANEL TO REMAIN. CONTRACTOR TO PROVIDE A NEW NAMEPLATE AND LABEL PANEL D3.
- (7) REMOVE AND DISCARD EXISTING ABANDONED JUNCTION BOX AND ALL ASSOCIATED WIRING AND CONDUIT.
- (8) EXISTING DISCONNECT SWITCH FOR A/C UNIT TO REMAIN.
- (9) EXISTING PANEL DPB TO REMAIN.
- (10) EXISTING PANEL DB TO REMAIN.
- (11) REMOVE AND DISCARD EXISTING ABANDONED CONDUIT AND WIRE. PATCH BRICK WALL REFER TO ARCHITECTURAL FOR DETAILS.
- (12) EXISTING PUMP CONTROL PANEL TO REMAIN.
- (13) EXISTING LIGHT FIXTURE TO REMAIN.
- (14) EXISTING JUNCTION BOX TO REMAIN.
- (15) EXISTING MAINTENANCE PANEL TO REMAIN. CONTRACTOR TO PROVIDE A NEW NAMEPLATE AND LABEL PANEL D4.
- (16) EXISTING A/C UNIT TO REMAIN.
- (17) NEW PANEL B25. CONTRACTOR TO EXTEND CONDUIT AND WIRE AS REQUIRED TO 1ST FLOOR EXISTING FUSIBLE PANEL TO CONNECT TO EXISTING LOADS USING EXISTING FUSIBLE PANEL SIDES AS A JUNCTION BOX. REFER TO PARTIAL POWER RISER DIAGRAM AND PANEL SCHEDULE FOR DETAILS. CONTRACTOR TO FIELD VERIFY EXACT CIRCUITS AND LOADS ASSOCIATED AND UPDATE PANEL SCHEDULE WITH EXISTING LOADS. COORDINATE WITH ARCHITECT FOR EXACT ROUTING.
- (18) NEW PANEL EB. CONNECT EXISTING LOADS FROM COURTYARD PANEL IN NEW PANEL EB. CONTRACTOR TO RE-ROUTE CONDUIT AND WIRING AS NECESSARY. REFER TO PARTIAL POWER RISER DIAGRAM AND PANEL SCHEDULE FOR PANEL DETAILS. CONTRACTOR TO FIELD VERIFY EXACT CIRCUITS AND LOADS ASSOCIATED AND UPDATE PANEL SCHEDULE WITH EXISTING LOADS. COORDINATE WITH ARCHITECT FOR EXACT ROUTING.
- (19) EXISTING MECHANICAL ROOM PANEL TO REMAIN. CONTRACTOR TO PROVIDE A NEW NAMEPLATE AND LABEL PANEL D5.
- (20) NEW PANEL A25. CONTRACTOR TO EXTEND/RE-ROUTE CONDUIT AND WIRE AS REQUIRED TO TO RECONNECT EXISTING LOADS FROM REMOVED DISCONNECT SWITCH AND PANEL. REFER TO KEYED NOTES 4 AND 5 FOR DETAILS. CONTRACTOR TO FIELD VERIFY EXACT CIRCUITS AND LOADS ASSOCIATED AND UPDATE PANEL SCHEDULE WITH EXISTING LOADS.

0 1' 4' 8'





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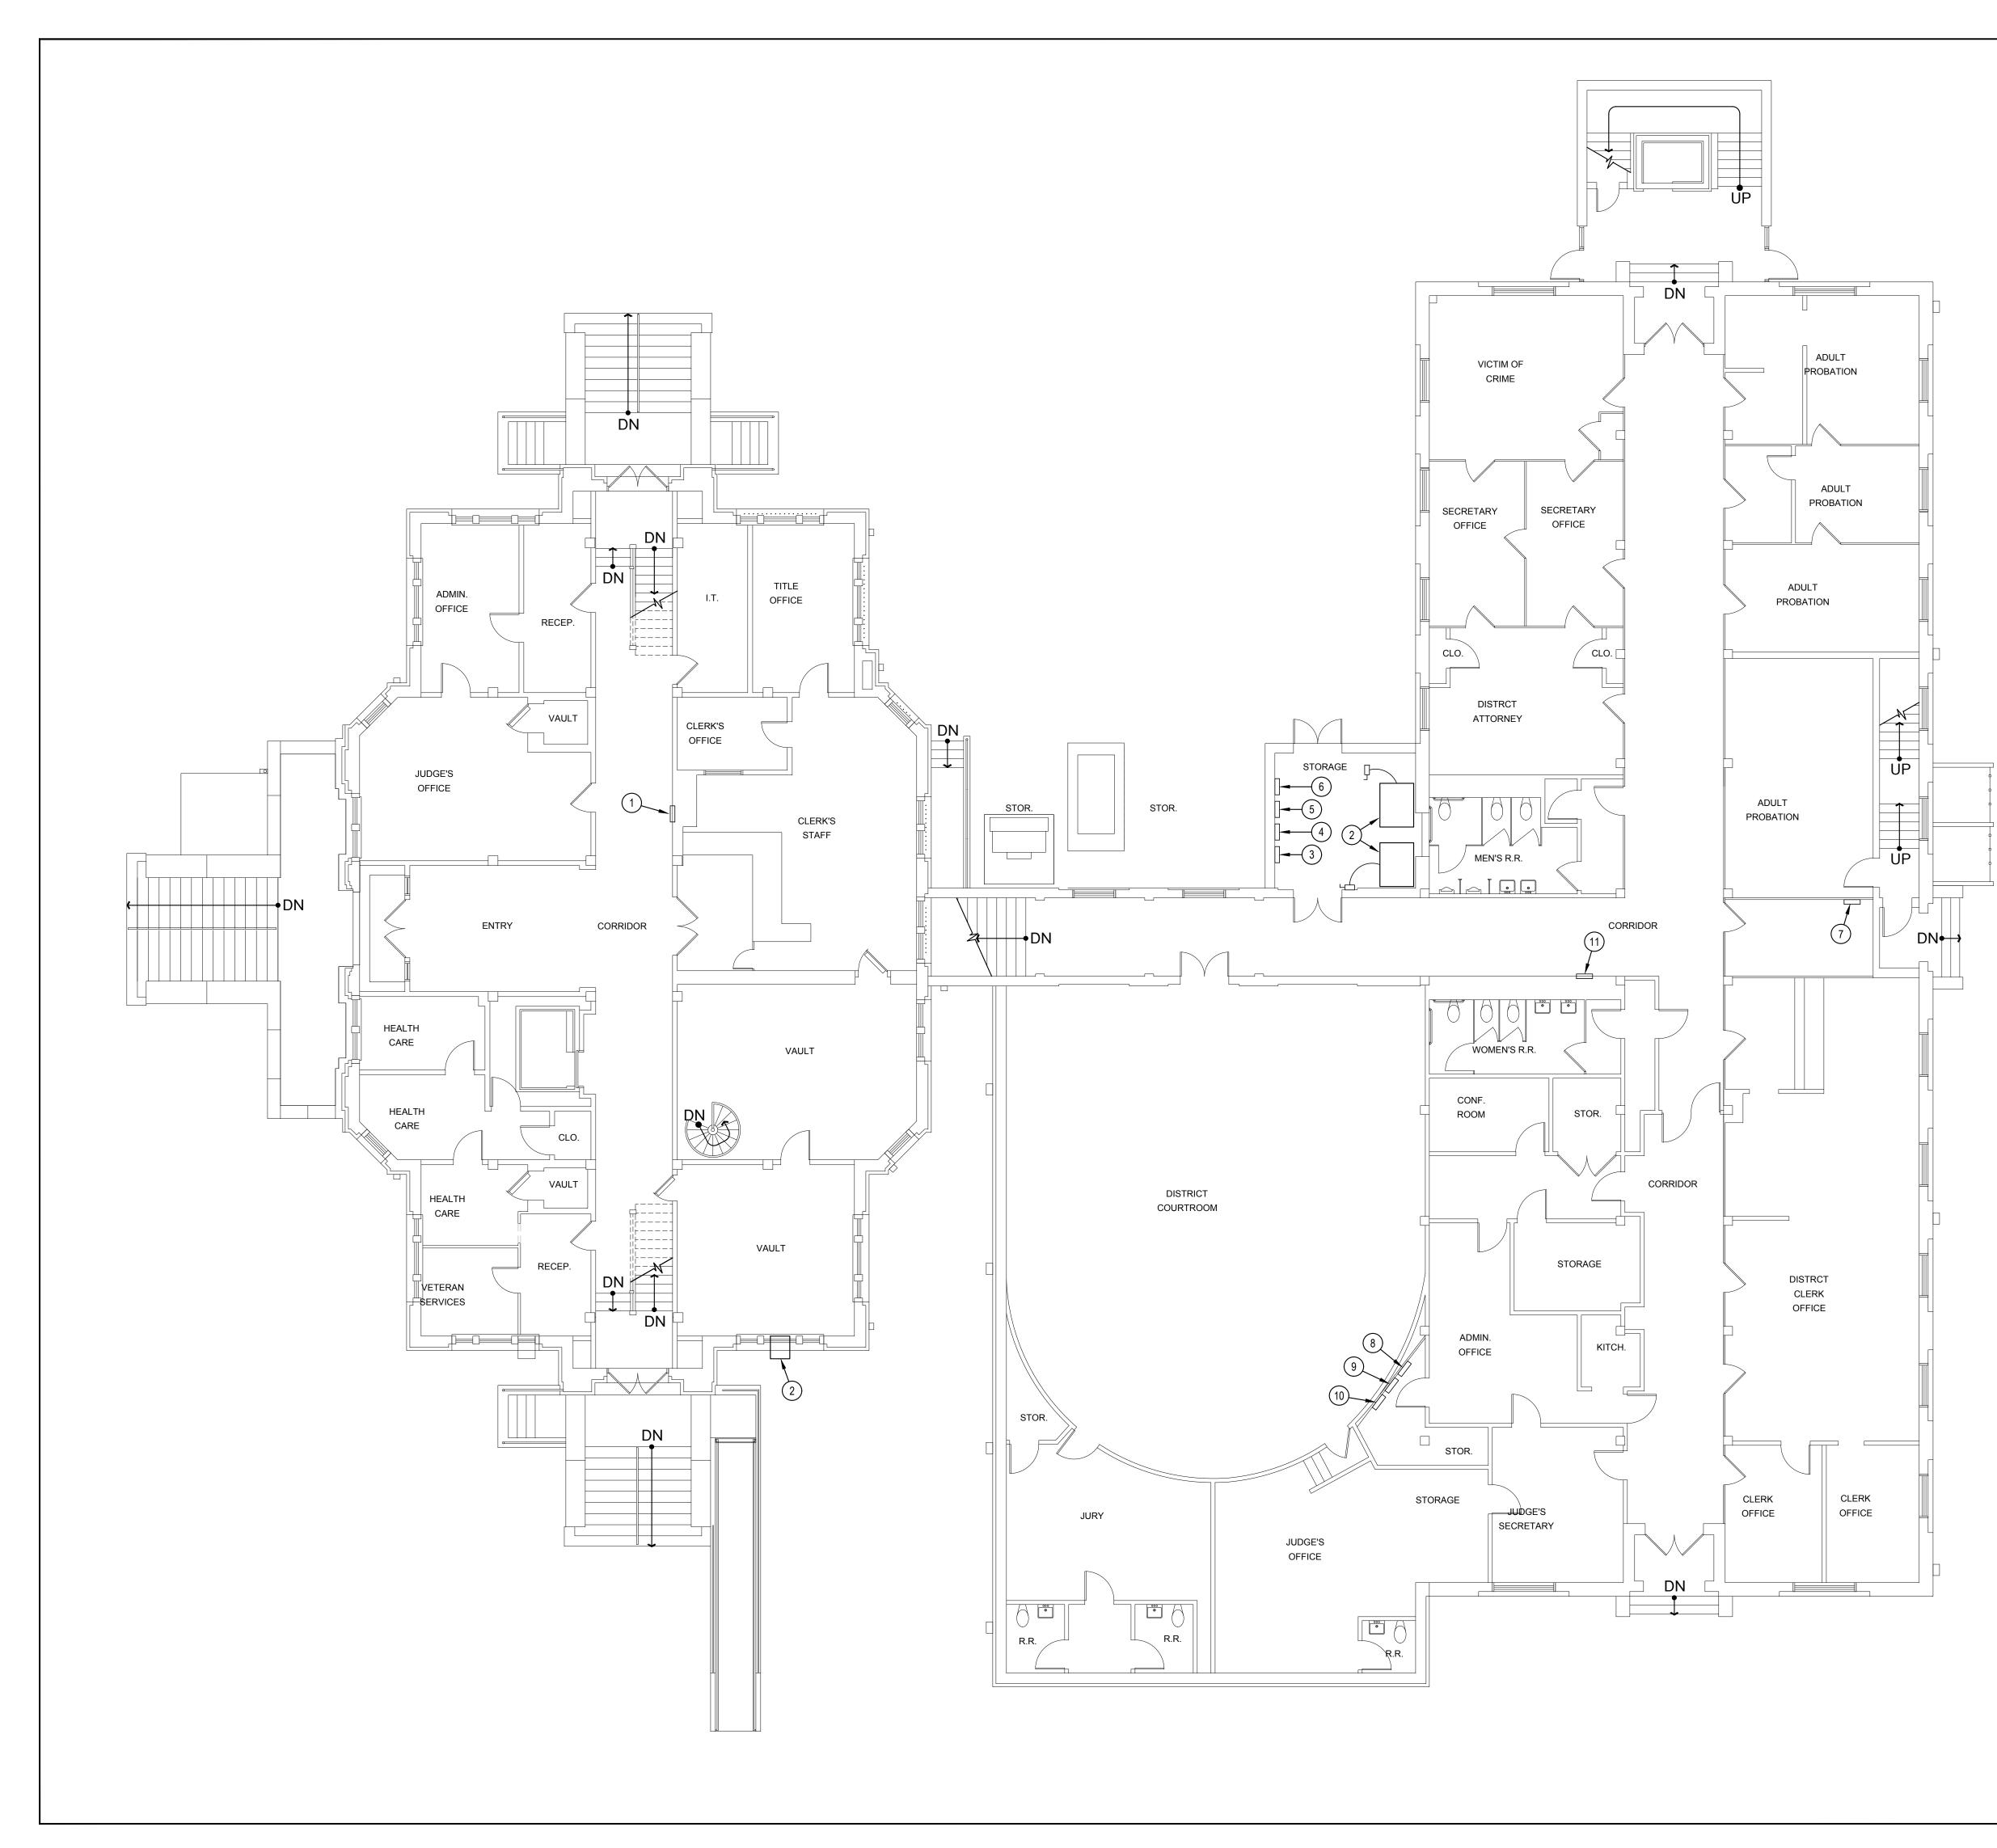
Date 06/19/2025

Sheet Name **BASEMENT ELECTRICAL** FLOOR PLAN

Sheet Number



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- GENERAL NOTES:
- 1. CONTRACTOR TO VERIFY LOCATIONS OF ALL EXISTING ELECTRICAL EQUIPMENT, DEVICES, ETC. DEVICES/EQUIPMENT MAY NOT REPRESENT ALL DEVICES/EQUIPMENT, AND CONTRACTOR SHALL BE RESPONSIBLE FOR REMOVING/RELOCATING DEVICES/EQUIPMENT NOT SHOWN AS REQUIRED FOR DEMOLITION.
- 2. ALL NEW ELECTRICAL WIRING AND CONDUIT IN PUBLIC OR SECONDARY SPACES SHALL BE CONCEALED BY SUSPENDED CEILINGS, FURR DOWNS, FURR OUTS OR WITHIN WALLS WITH THE EXCEPTION OF MECHANICAL AND ELECTRICAL SPACES UNLESS OTHERWISE NOTED. COORDINATE WITH ARCHITECT IF NOT POSSIBLE.

KEYED NOTES:


- (1) DISCONNECT EXISTING FUSIBLE PANEL FROM EXISTING POWER SUPPLY. CONTRACTOR TO FIELD VERIFY PANEL FEEDER (EXPECTED TO BE MAINTENANCE PANEL D4). CONTRACTOR TO VERIFY EXISTING LOADS FOR RE-ROUTING TO NEW PANEL B25. EXISTING SPACE AROUND PANEL SIDES TO BE USED FOR SPLICING EXISTING LOAD BRANCH CIRCUITS. COORDINATE WITH ARCHITECT FOR EXACT ROUTING.
- (2) EXISTING A/C UNIT TO REMAIN.
- (3) EXISTING EMERGENCY PANEL EDP TO REMAIN. CONNECT EXISTING PANEL EDP INTO AUTOMATIC TRANSFER SWITCH USING EXISTING WIRING AND CONDUIT. REFER TO PARTIAL POWER RISER DIAGRAM AND PANEL SCHEDULE FOR DETAILS.
- (4) EXISTING PANEL D1 TO REMAIN.
- 5 EXISTING PANEL D2 TO REMAIN.
- 6 EXISTING PANEL DP1 TO REMAIN.
- (7) EXISTING EMERGENCY PANEL TO REMAIN. CONTRACTOR TO PROVIDE A NEW NAMEPLATE AND LABEL PANEL E4. REFER TO SITE PLAN AND PARTIAL POWER RISER DIAGRAM FOR DETAILS.
- 8 EXISTING EMERGENCY PANEL E3 TO REMAIN.
- (9) EXISTING PANEL L1 TO REMAIN.
- (10) EXISTING PANEL L3 TO REMAIN.
- (11) EXISTING PANEL IN HALLWAY TO REMAIN. CONTRACTOR TO PROVIDE A NEW NAMEPLATE AND LABEL PANEL D6. CONTRACTOR TO DETERMINE THE FEEDER SOURCE FOR THE PANEL (BELIEVED TO BE PANEL D1) AND TO LABEL THE ASSOCIATED BREAKER ACCORDINGLY.

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Sheet Name FIRST FLOOR ELECTRICAL FLOOR PLAN

Sheet Number



First Floor Plan Scale: 1/8" = 1'-0" 0 1' 4'

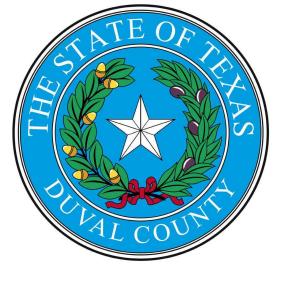



- 1. CONTRACTOR TO VERIFY LOCATIONS OF ALL EXISTING ELECTRICAL EQUIPMENT, DEVICES, ETC. DEVICES/EQUIPMENT MAY NOT REPRESENT ALL DEVICES/EQUIPMENT, AND CONTRACTOR SHALL BE RESPONSIBLE FOR REMOVING/RELOCATING DEVICES/EQUIPMENT NOT SHOWN AS REQUIRED FOR DEMOLITION.
- 2. ALL NEW ELECTRICAL WIRING AND CONDUIT IN PUBLIC OR SECONDARY SPACES SHALL BE CONCEALED BY SUSPENDED CEILINGS, FURR DOWNS, FURR OUTS OR WITHIN WALLS WITH THE EXCEPTION OF MECHANICAL AND ELECTRICAL SPACES UNLESS OTHERWISE NOTED. COORDINATE WITH ARCHITECT IF NOT POSSIBLE.

### KEYED NOTES:

- (1) DISCONNECT EXISTING FUSIBLE PANEL FROM EXISTING POWER SUPPLY. CONTRACTOR TO FIELD VERIFY PANEL FEEDER (EXPECTED TO BE MAINTENANCE PANEL D4). CONTRACTOR TO VERIFY EXISTING LOADS FOR RE-ROUTING TO NEW PANEL C25. EXISTING SPACE AROUND PANEL SIDES TO BE USED FOR SPLICING EXISTING LOAD BRANCH CIRCUITS. COORDINATE WITH ARCHITECT FOR EXACT ROUTING.
- 2 EXISTING IT CABINET TO REMAIN. REMOVE AND DISCARD EXISTING TELECOMMUNICATION CABLE THAT EXTENDS TO COURTYARD UTILITY POLE. CONNECT NEW TELECOMMUNICATION CABLE TO EXISTING IT CABINET. REFER TO SITE PLAN FOR DETAILS.
- 3 EXISTING EMERGENCY PANEL E1 TO REMAIN. REFER TO PARTIAL POWER RISER DIAGRAM FOR DETAILS.
- (4) EXISTING EMERGENCY PANEL E2 TO REMAIN.
- 5 EXISTING EMERGENCY PANEL TO REMAIN. CONTRACTOR TO PROVIDE A NAMEPLATE AND LABEL PANEL E5.

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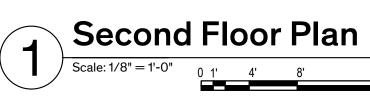
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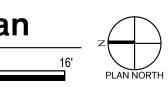
Sheet Name SECOND FLOOR ELECTRICAL FLOOR PLAN


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0 1' 4'





- 1. CONTRACTOR TO VERIFY LOCATIONS OF ALL EXISTING ELECTRICAL EQUIPMENT, DEVICES, ETC. DEVICES/EQUIPMENT MAY NOT REPRESENT ALL DEVICES/EQUIPMENT, AND CONTRACTOR SHALL BE RESPONSIBLE FOR REMOVING/RELOCATING DEVICES/EQUIPMENT NOT SHOWN AS REQUIRED FOR DEMOLITION.
- 2. CONTRACTOR TO FIELD VERIFY ALL RE-ROUTED LOADS AND LABEL NEW PANEL SCHEDULE ACCORDINGLY.
- 3. ALL NEW ELECTRICAL WIRING AND CONDUIT IN PUBLIC OR SECONDARY SPACES SHALL BE CONCEALED BY SUSPENDED CEILINGS, FURR DOWNS, FURR OUTS OR WITHIN WALLS WITH THE EXCEPTION OF MECHANICAL AND ELECTRICAL SPACES UNLESS OTHERWISE NOTED. COORDINATE WITH ARCHITECT IF NOT POSSIBLE.

### **KEYED NOTES:**

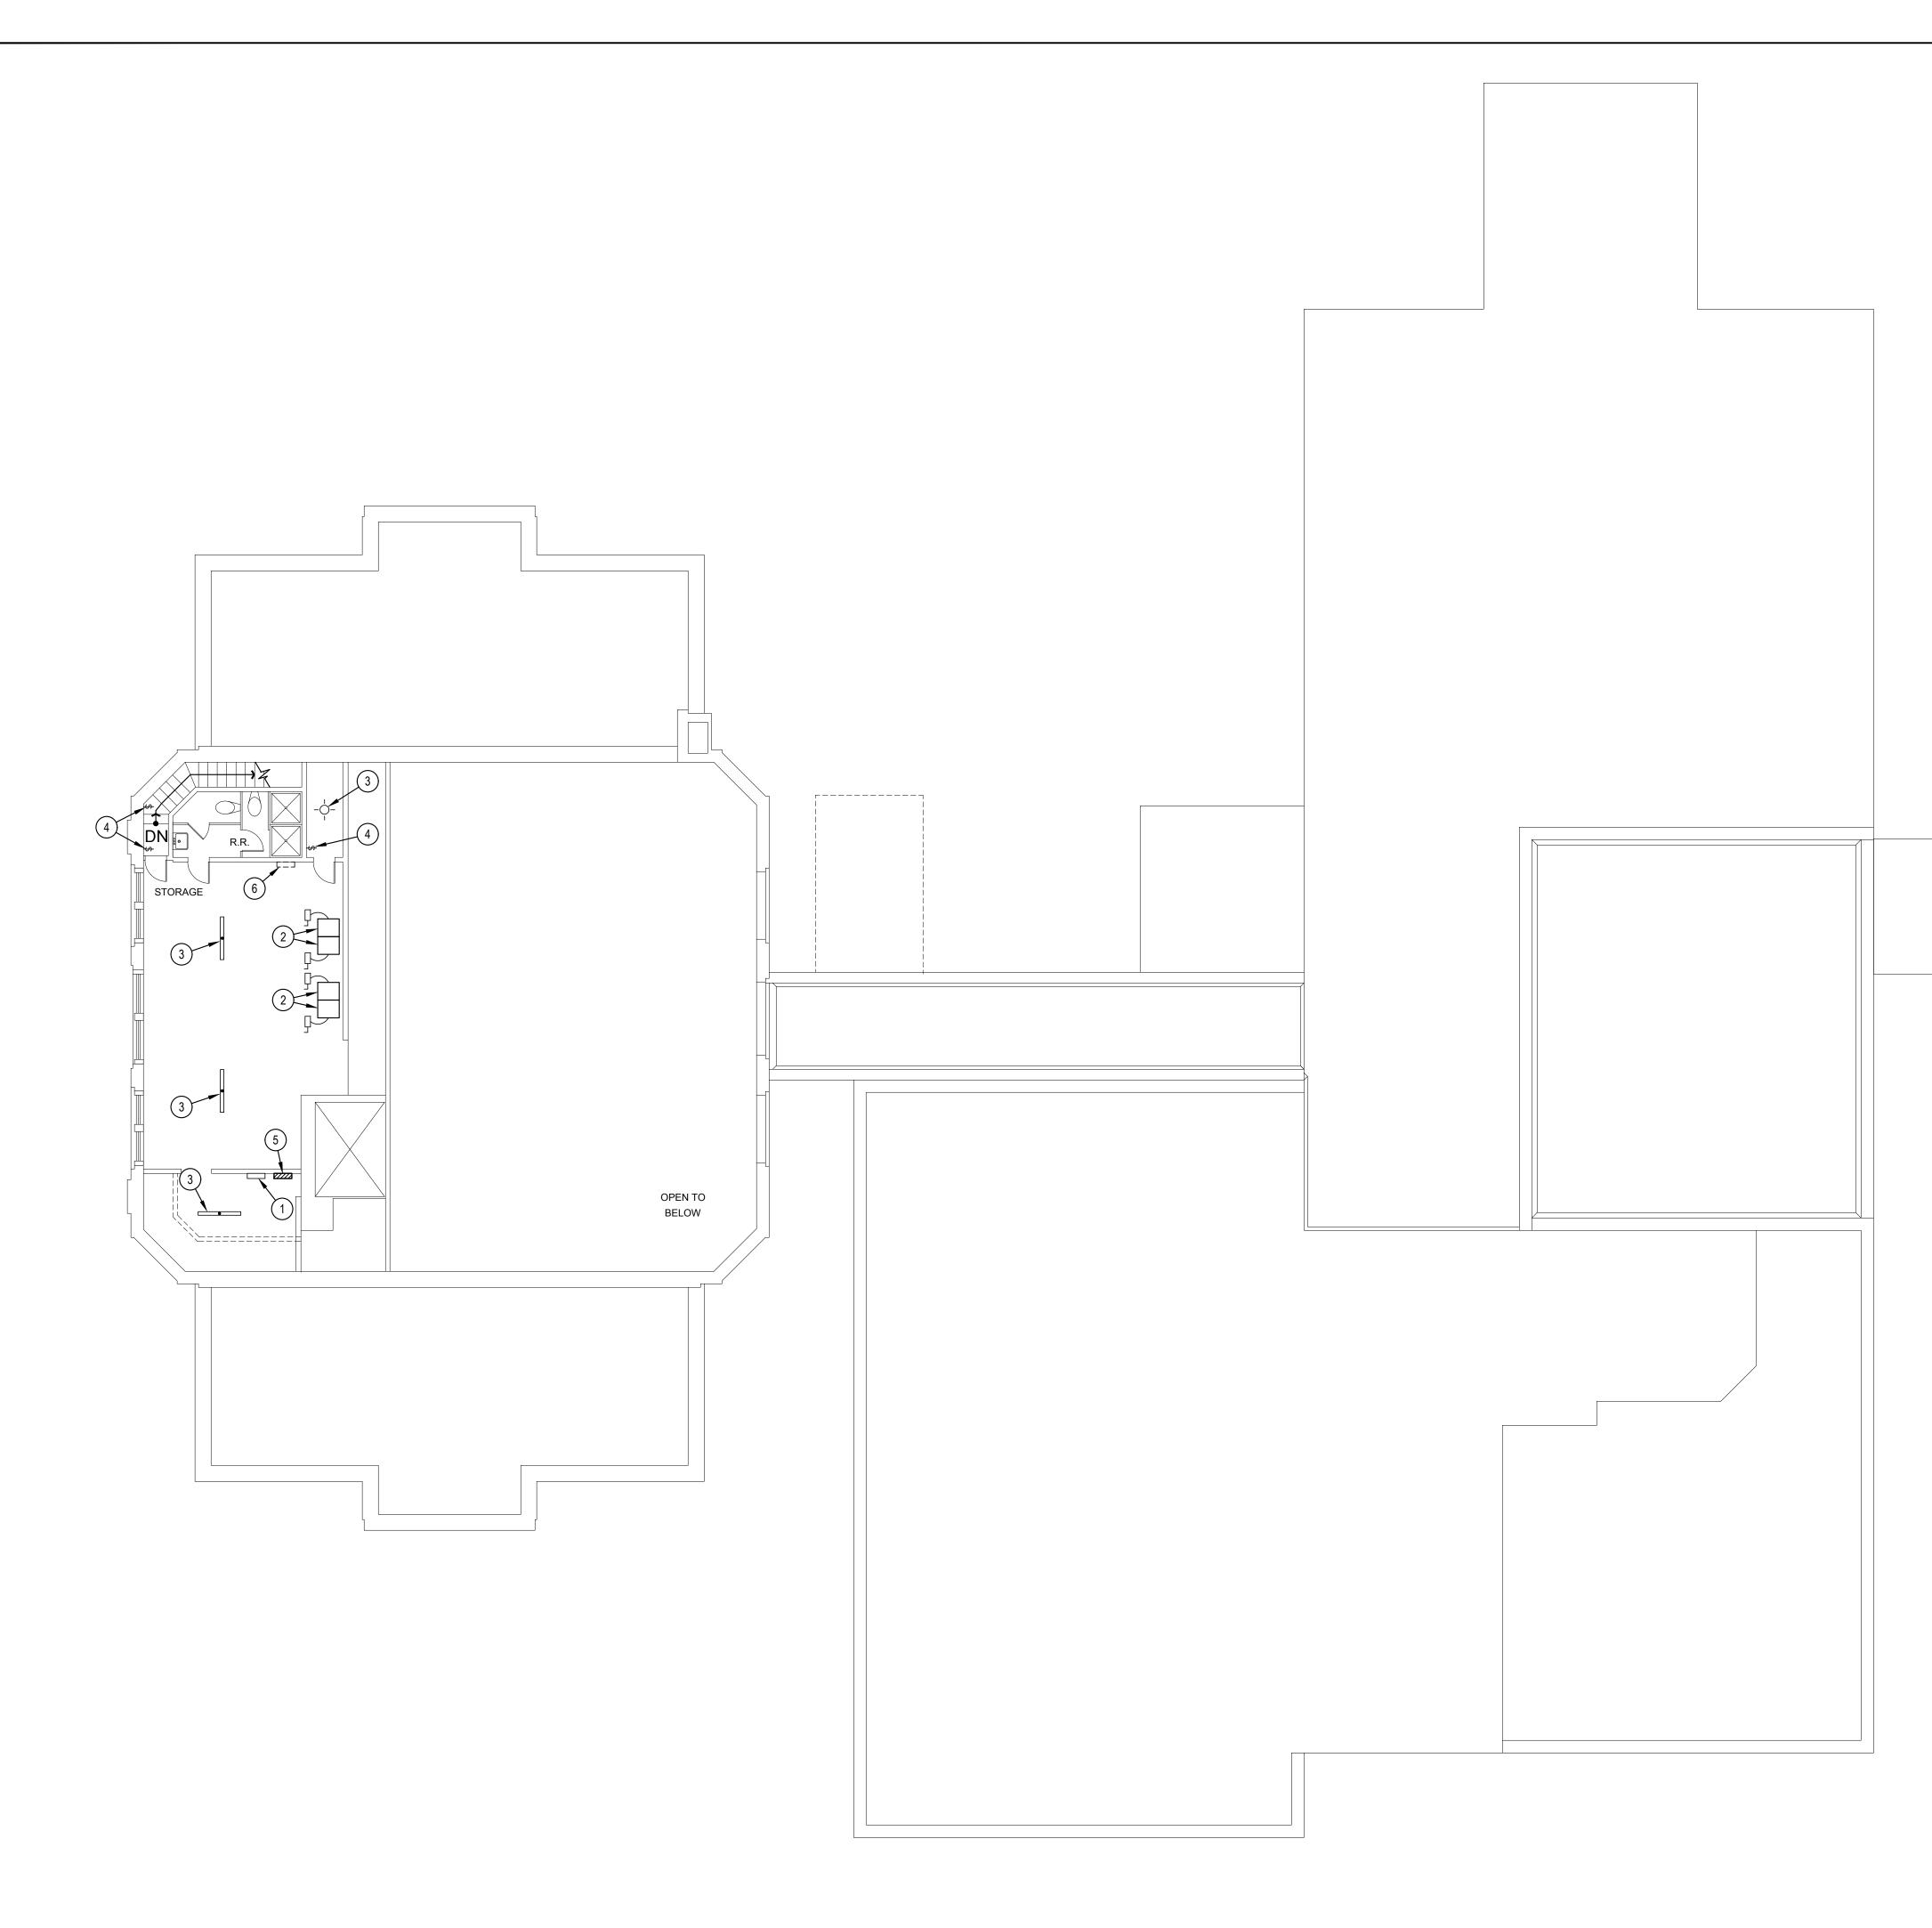- (1) EXISTING PANEL DP3 TO REMAIN.
- 2 EXISTING A/C UNITS TO REMAIN.
- 3 EXISTING LIGHT FIXTURES TO REMAIN.
- (4) EXISTING SWITCH TO REMAIN.
- 5 NEW PANEL C25. CONTRACTOR TO EXTEND CONDUIT AND WIRE AS NECESSARY TO SECOND FLOOR EXISTING FUSIBLE PANEL TO CONNECT TO EXISTING LOADS USING EXISTING FUSIBLE PANEL SIDES AS A JUNCTION BOX. REFER TO PARTIAL POWER RISER DIAGRAM AND PANEL SCHEDULE FOR DETAILS. CONTRACTOR TO FIELD VERIFY EXACT CIRCUITS AND LOADS ASSOCIATED AND UPDATE PANEL SCHEDULE WITH EXISTING LOADS. COORDINATE WITH ARCHITECT FOR EXACT ROUTING.
- 6 EXISTING PANEL TO BE REMOVED. CONTRACTOR TO EXTEND CONDUIT AND WIRE AS REQUIRED TO RE-ROUTE EXISTING PANEL LOADS TO NEW PANEL C25. ALL CONDUIT AND WIRING TO BE ROUTED THROUGH ATTIC.

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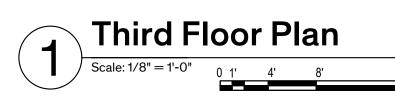
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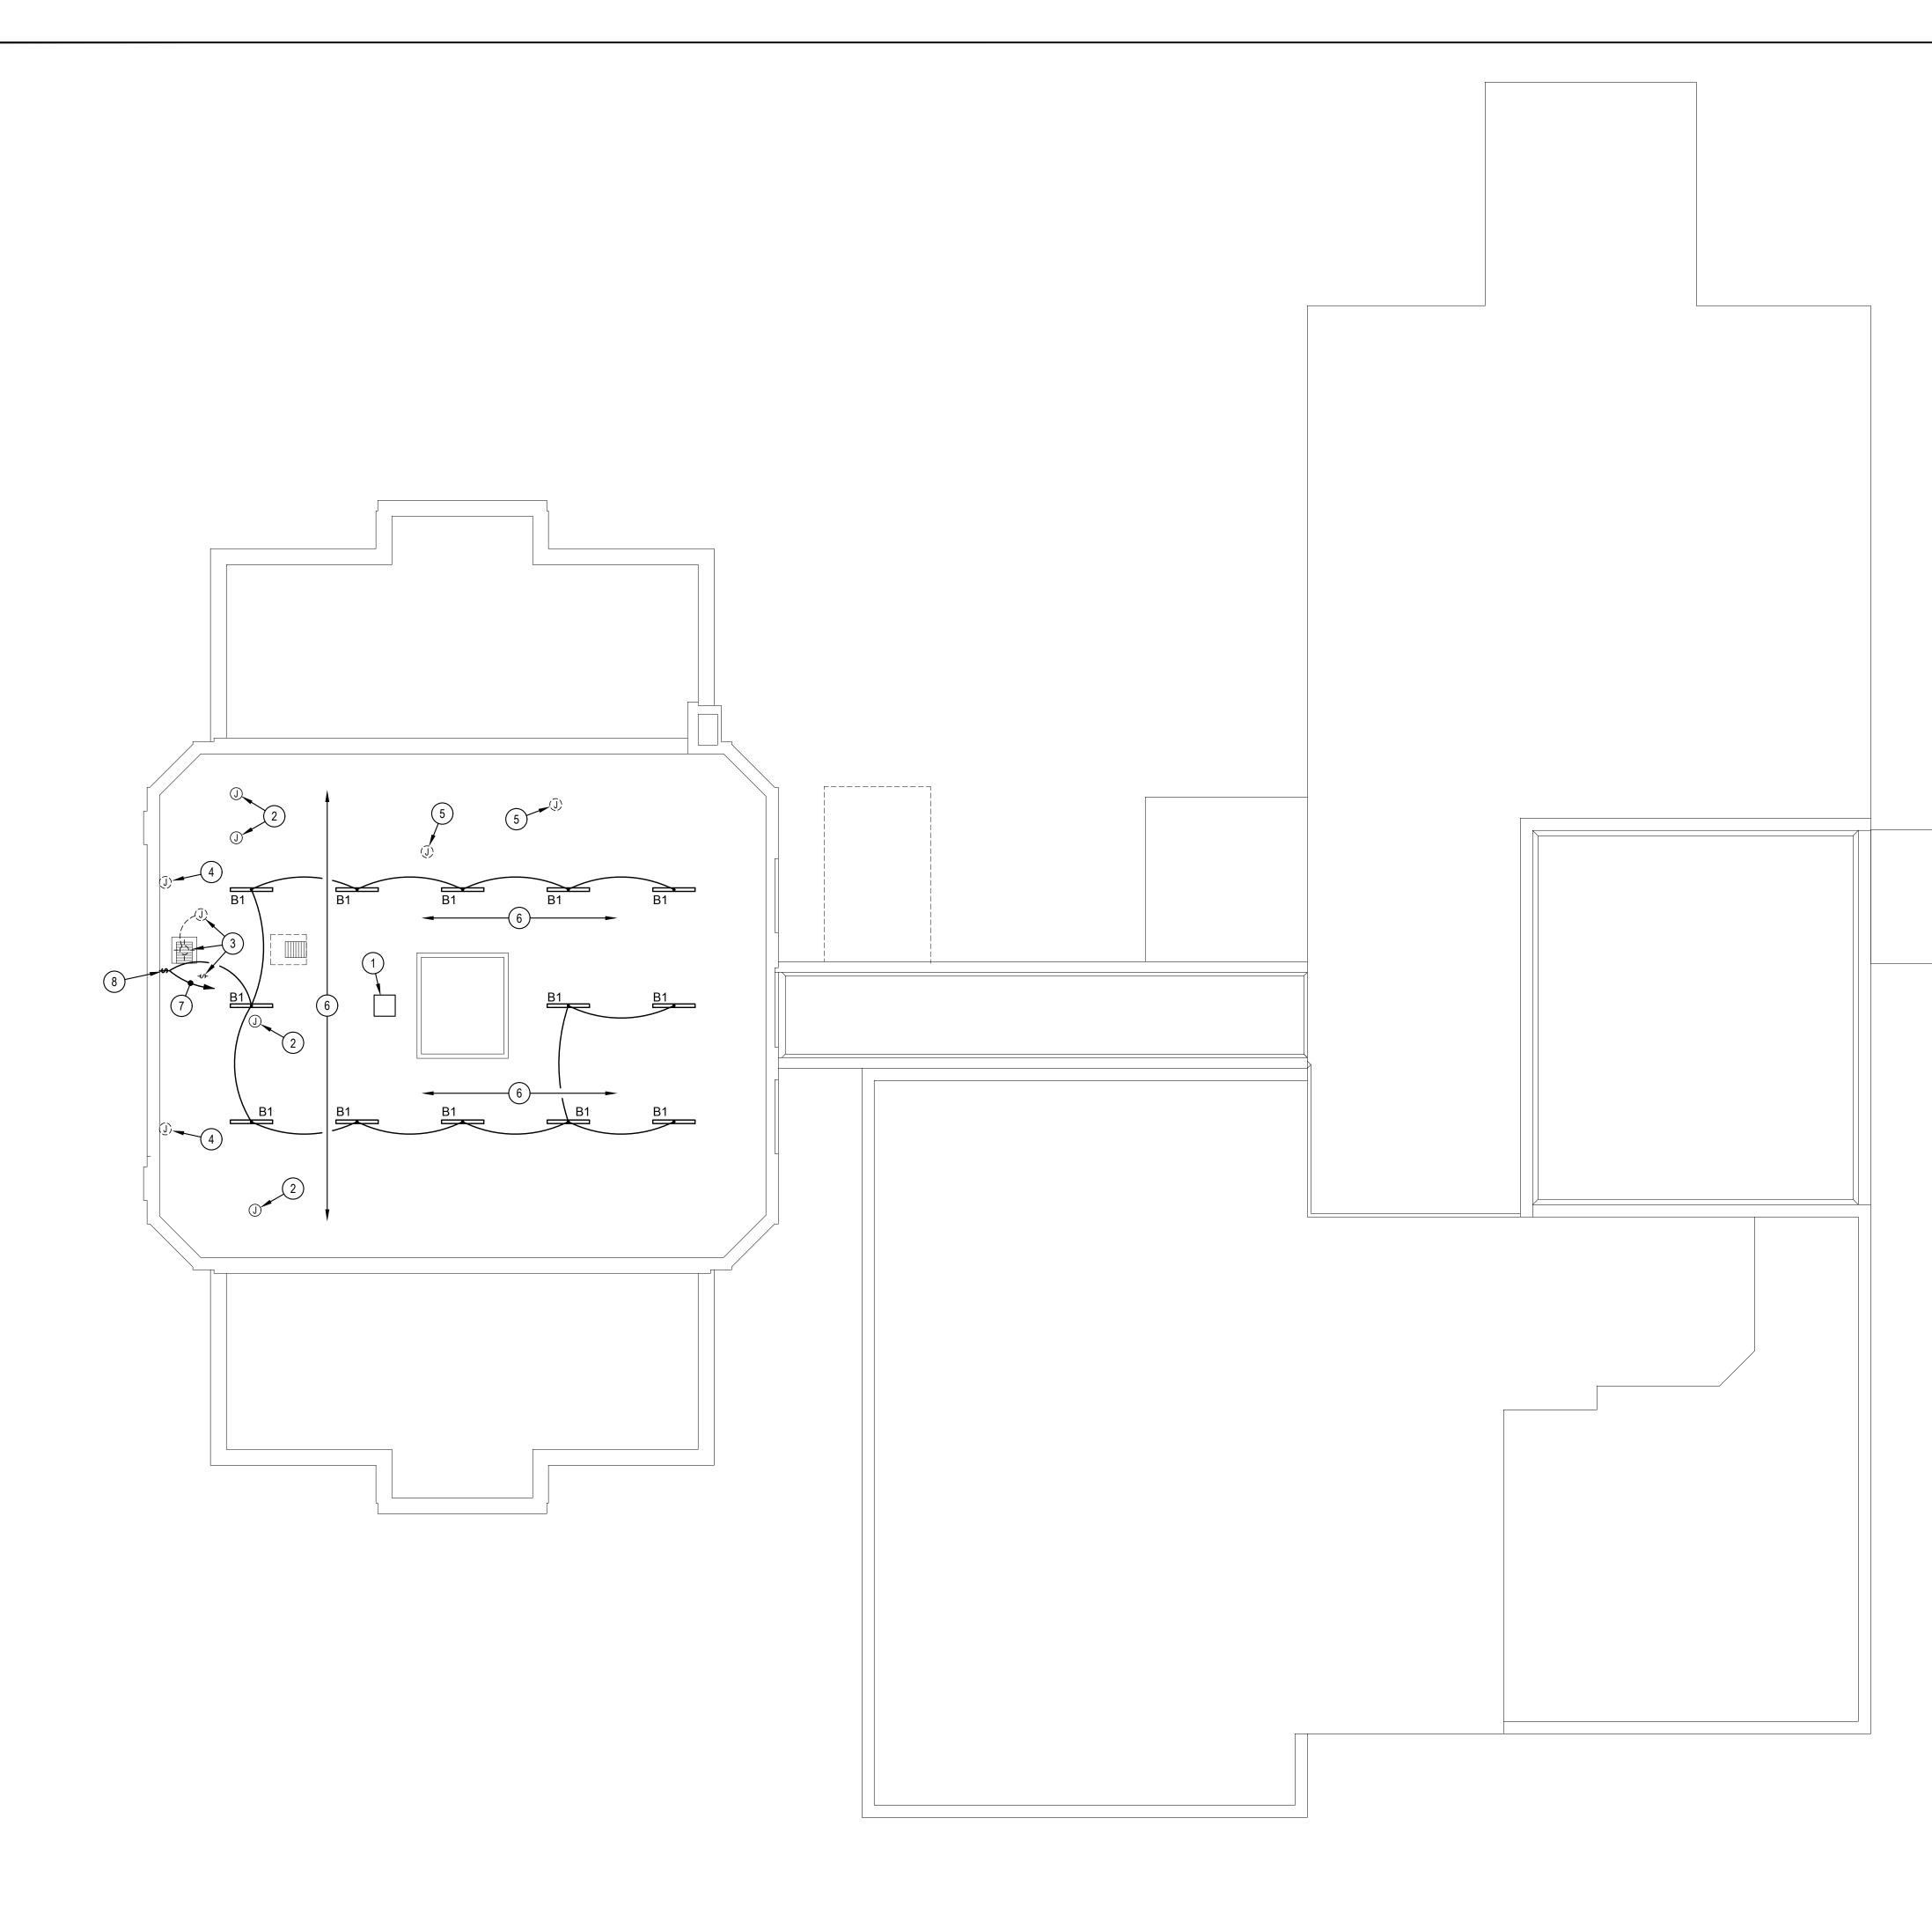
Date 06/19/2025

Sheet Name THIRD FLOOR ELECTRICAL FLOOR PLAN









- 1. CONTRACTOR TO VERIFY LOCATIONS OF ALL EXISTING ELECTRICAL EQUIPMENT, DEVICES, ETC. DEVICES/EQUIPMENT MAY NOT REPRESENT ALL DEVICES/EQUIPMENT, AND CONTRACTOR SHALL BE RESPONSIBLE FOR REMOVING/RELOCATING DEVICES/EQUIPMENT NOT SHOWN AS REQUIRED FOR DEMOLITION.
- 2. CONTRACTOR TO REMOVE AND DISCARD ANY EXISTING ABANDONED WIRING AND CONDUIT.

### KEYED NOTES:

- 1 EXISTING ROOF PENETRATION, REMOVE AND DISCARD EXISTING ABANDONED CONDUIT AND WIRING. PATCH EXISTING ROOF PENETRATION.
- 2 EXISTING JUNCTION BOX FOR THIRD FLOOR LIGHTING TO REMAIN. EXISTING ABANDONED CONDUIT AND WIRING TO BE REMOVED.
- 3 REMOVE AND DISCARD EXISTING LIGHT FIXTURE, JUNCTION BOX AND SWITCH. REMOVE AND DISCARD EXISTING CONDUIT AND WIRING TO WALL AND INSTALL NEW JUNCTION BOX ON WALL FOR LIGHTING INSTALLATION.
- 4 CONTRACTOR TO FIELD VERIFY IF EXISTING JUNCTION BOX AND WIRING ARE ABANDONED. REMOVE AND DISCARD EXISTING JUNCTION BOX AND WIRING IF THEY ARE ABANDONED.
- 5 CONTRACTOR TO FIELD VERIFY EXISTING CIRCUITS IN EXISTING JUNCTION BOX. CONTRACTOR TO REMOVE AND DISCARD EXISTING ABANDONED CIRCUITS THEN DISCONNECT EXISTING CIRCUITS IN EXISTING JUNCTION BOX, REMOVE AND DISCARD EXISTING JUNCTION BOX, AND INSTALL NEW JUNCTION BOX(ES) AND CONDUIT FOR EXISTING CIRCUITS.
- 6 CONTRACTOR TO FIELD VERIFY EXISTING CIRCUITS AND CONDUIT, AND REMOVE AND DISCARD EXISTING ABANDONED WIRING AND CONDUIT.
- (7) CONNECT TO EXISTING 120V LIGHTING CIRCUIT IN THE AREA.
- (8) INSTALL NEW SWITCH SURFACE MOUNTED ON BRICK WALL.

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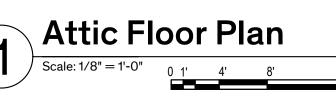


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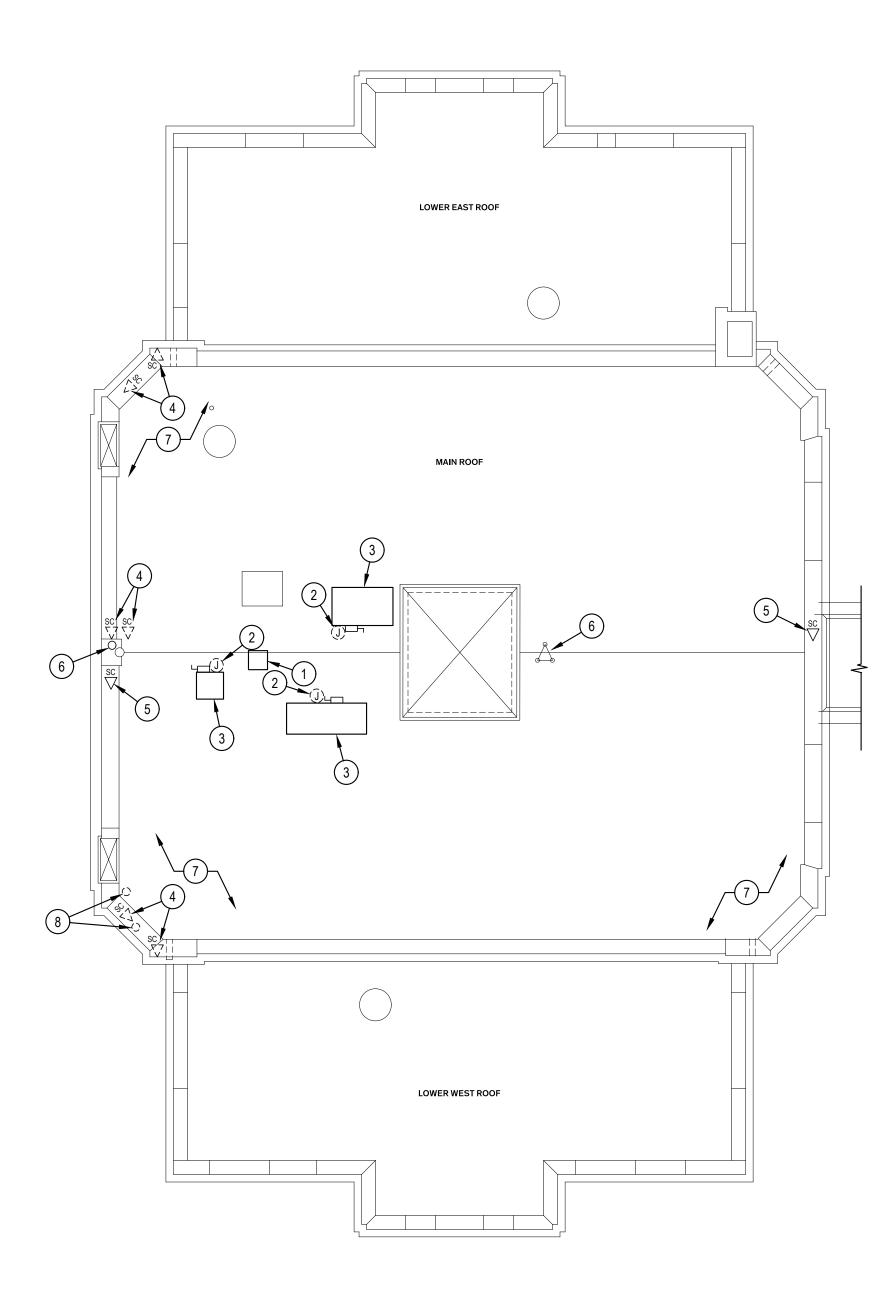
Sheet Name ATTIC ELECTRICAL FLOOR PLAN











- 1. CONTRACTOR TO VERIFY LOCATIONS OF ALL EXISTING ELECTRICAL EQUIPMENT, DEVICES, ETC. DEVICES/EQUIPMENT MAY NOT REPRESENT ALL DEVICES/EQUIPMENT, AND CONTRACTOR SHALL BE RESPONSIBLE FOR REMOVING/RELOCATING DEVICES/EQUIPMENT NOT SHOWN AS REQUIRED FOR DEMOLITION.
- 2. CONTRACTOR TO REMOVE AND DISCARD ANY EXISTING ABANDONED WIRING AND CONDUIT.

**KEYED NOTES:** 


- 1 EXISTING ROOF PENETRATION, REMOVE AND DISCARD EXISTING ABANDONED CONDUIT AND WIRING. PATCH EXISTING ROOF PENETRATION.
- 2 REMOVE AND DISCARD EXISTING ABANDONED JUNCTION BOX AND ALL ASSOCIATED CONDUIT AND WIRING.
- (3) EXISTING A/C UNIT TO REMAIN.
- (4) REMOVE EXISTING CAMERA PRIOR TO ROOF WORK AND RETAIN FOR REINSTALLATION. EXISTING WIRING TO REMAIN FOR REINSTALLATION. REINSTALL RETAINED CAMERA AFTER ROOF WORK IS COMPLETE. REFER TO ARCHITECTURAL FOR DETAILS.
- 5 EXISTING CAMERA TO REMAIN.
- (6) EXISTING ANTENNA TO REMAIN.
- 7 REMOVE EXISTING LIGHTNING PROTECTION PRIOR TO ROOF WORK AND RETAIN FOR REINSTALLATION. REINSTALL RETAINED LIGHTNING PROTECTION SYSTEM AFTER ROOF WORK IS COMPLETE. REFER TO ARCHITECTURAL FOR DETAILS.
- 8 REMOVE EXISTING ANTENNA PRIOR TO ROOF WORK AND RETAIN FOR REINSTALLATION. EXISTING WIRING TO REMAIN FOR REINSTALLATION. REINSTALL RETAINED ANTENNA AFTER ROOF WORK IS COMPLETE, COORDINATE WITH OWNER FOR EXACT ANTENNA DIRECTIONS REQUIRED. REFER TO ARCHITECTURAL FOR DETAILS.

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June 19, 2025

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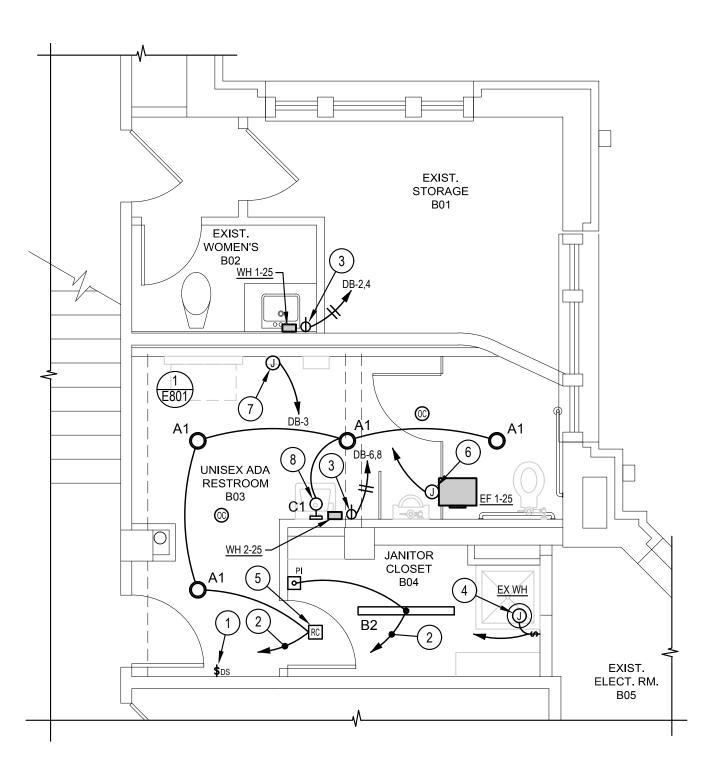
Date 06/19/2025

Sheet Name **ROOF ELECTRICAL** FLOOR PLAN



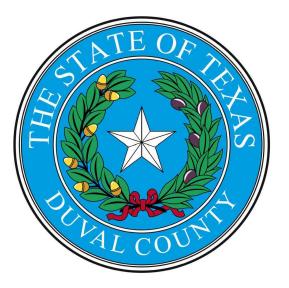









### MECHANICAL EQUIPMENT CONNECTION CHART

WATER HEAT	ER SCHE	DULE				
				UNIT	UNIT	
DESIG.	KW	VOLT	PH	FLA	MCA	UNIT
EX WH	1.5	120	1	12.5	15.6	120VAC 20A
WH 1-25	3.0	208	1	14.4	18.0	Co
WH 2-25	3.0	208	1	14.4	18.0	Co
	*					•
WATER HEAT	ER SCHE	DULE				
				UNIT	UNIT	
DESIG.	WATTS	VOLT	PH	FLA	MCA	UNIT
EF 1-25	28	120	1	1.2	1.5	Facto
NOTES:						
1	FINAL C	ONNEC	OTION	I AT UNI	t with l	IQUID-TIGHT F
2	2 MOUNT	TOGGL	E SV	VITCH C	N WALL	AT STANDARI
DESIG.         KW         VOLT         PH         FLA         MCA         UN           EX WH         1.5         120         1         12.5         15.6         120VAC 2           WH 1-25         3.0         208         1         14.4         18.0         14.4         18.0           WH 2-25         3.0         208         1         14.4         18.0         14.4         18.0         14.4         18.0           WATER HEATER SCHEDULE         UNIT         UNIT         UNIT         14.4         18.0         14.4         18.0         14.4         18.0         14.4         18.0         14.4         18.0         14.4         18.0         14.4         18.0         14.4         18.0         14.4         18.0         14.4         18.0         14.4         18.0         14.4         18.0         14.4         18.0         14.4         14.4         18.0         14.4					G SWITCH OP	
4		E AN S	OOV	V 3-12 C	ORD WIT	H A NEMA 6-2
•	•					

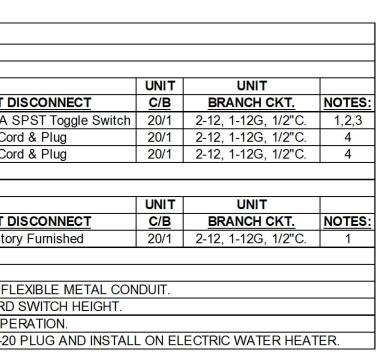

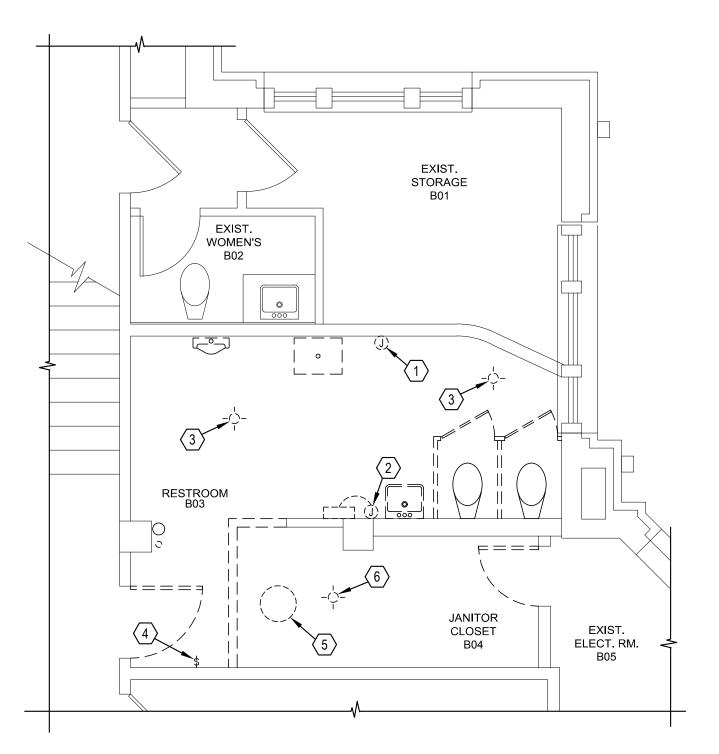



ALTERNATE NO. 2 REHABILITATE MEN'S RESTROOM AT BASEMENT LEVEL TO ADA COMPLIANT UNISEX RESTROOM, REFER TO SPEC. SECT. 01230-ALTERNATES

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### GENERAL NOTES:

- 1. CONTRACTOR TO VERIFY LOCATIONS OF ALL EXISTING ELECTRICAL EQUIPMENT, DEVICES, ETC. DEVICES/EQUIPMENT MAY NOT REPRESENT ALL DEVICES/EQUIPMENT, AND CONTRACTOR SHALL BE RESPONSIBLE FOR REMOVING/RELOCATING DEVICES/EQUIPMENT NOT SHOWN AS REQUIRED FOR DEMOLITION.
- 2. REFER TO DIGITAL OCCUPANCY SENSOR DIAGRAM AS REFERENCED.
- 3. ALL NEW ELECTRICAL WIRING AND CONDUIT IN PUBLIC OR SECONDARY SPACES SHALL BE CONCEALED BY SUSPENDED CEILINGS, FURR DOWNS, FURR OUTS OR WITHIN WALLS WITH THE EXCEPTION OF MECHANICAL AND ELECTRICAL SPACES UNLESS OTHERWISE NOTED. COORDINATE WITH ARCHITECT IF NOT POSSIBLE.


### DEMOLITION KEYED NOTES:


- (1) REMOVE AND DISCARD EXISTING ABANDONED JUNCTION BOX AND ALL ASSOCIATED WIRING.
- 2 REMOVE AND DISCARD EXISTING JUNCTION BOX, HAND DRYER AND ALL ASSOCIATED WIRE.
- 3 REMOVE AND DISCARD EXISTING LIGHT FIXTURE, EXISTING CONDUIT AND WIRE TO REMAIN FOR REINSTALLATION.
- 4 REMOVE AND DISCARD EXISTING SWITCH AND ALL ASSOCIATED WIRING. EXISTING JUNCTION BOX AND CONDUIT TO REMAIN FOR REINSTALLATION.
- 5 DISCONNECT EXISTING POWER CONNECTION TO EXISTING WATER HEATER. REMOVE AND DISCARD EXISTING WIRING AND CONDUIT. CONTRACTOR TO FIELD VERIFY EXACT CIRCUIT.
- $\langle 6 \rangle$  REMOVE AND DISCARD EXISTING LIGHT FIXTURE AND ALL ASSOCIATED WIRING.

### KEYED NOTES:

- (1) INSTALL NEW SWITCH IN EXISTING JUNCTION BOX.
- 2 CONNECT TO EXISTING 120V LIGHTING CIRCUIT IN THE AREA EXTEND CONDUIT AND WIRING AS NECESSARY. CONTRACTOR TO FIELD VERIFY EXACT CIRCUIT.
- 3 INSTALL A NEMA 6-20R RECEPTACLE UNDER FIXTURE FOR INSTANTANEOUS HOT WATER HEATER. REFER TO MECHANICAL EQUIPMENT CONNECTION CHART FOR DETAILS.
- (4) CONTRACTOR TO RECONNECT RETAINED WATER HEATER TO EXISTING CIRCUIT. CONTRACTOR TO EXTEND NEW WIRING AND CONDUIT TO CONNECT TO WATER HEATER. REFER TO MECHANICAL EQUIPMENT CONNECTION CHART FOR DETAILS.
- 5 INSTALL NEW ROOM CONTROLLER IN OPEN CEILING SPACE. CONTRACTOR TO COORDINATE EXACT LOCATION WITH THE OWNER.
- 6 NEW EXHAUST FAN. CONNECT TO EXISTING RESTROOM LIGHTING CIRCUIT SUCH THAT FAN TURNS ON WITH RESTROOM LIGHTING. REFER TO MECHANICAL EQUIPMENT CONNECTION CHART FOR DETAILS.
- (7) CONNECT TO NEW HAND DRYER. HOMERUN 2-12, 1-12G, 1/2"C TO EXISTING SPARE 20/1 C/B IN EXISTING PANEL DB.

(8) MOUNT NEW WALL FIXTURE ABOVE MIRROR.

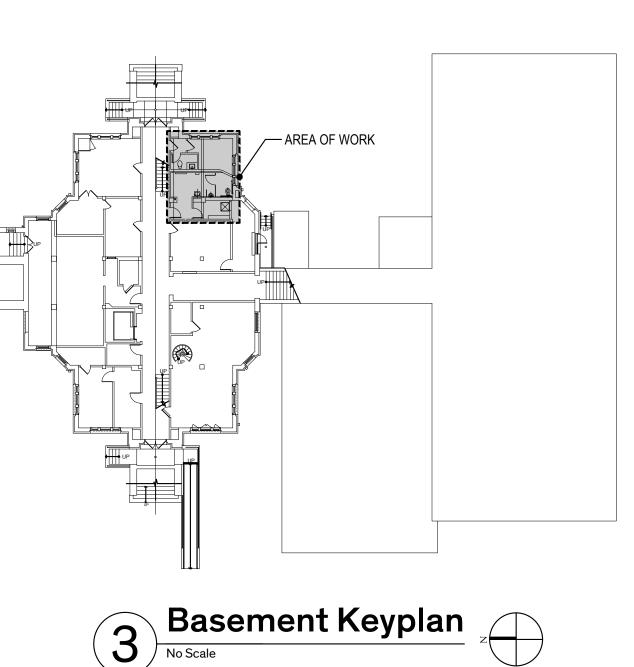

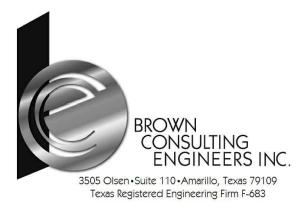



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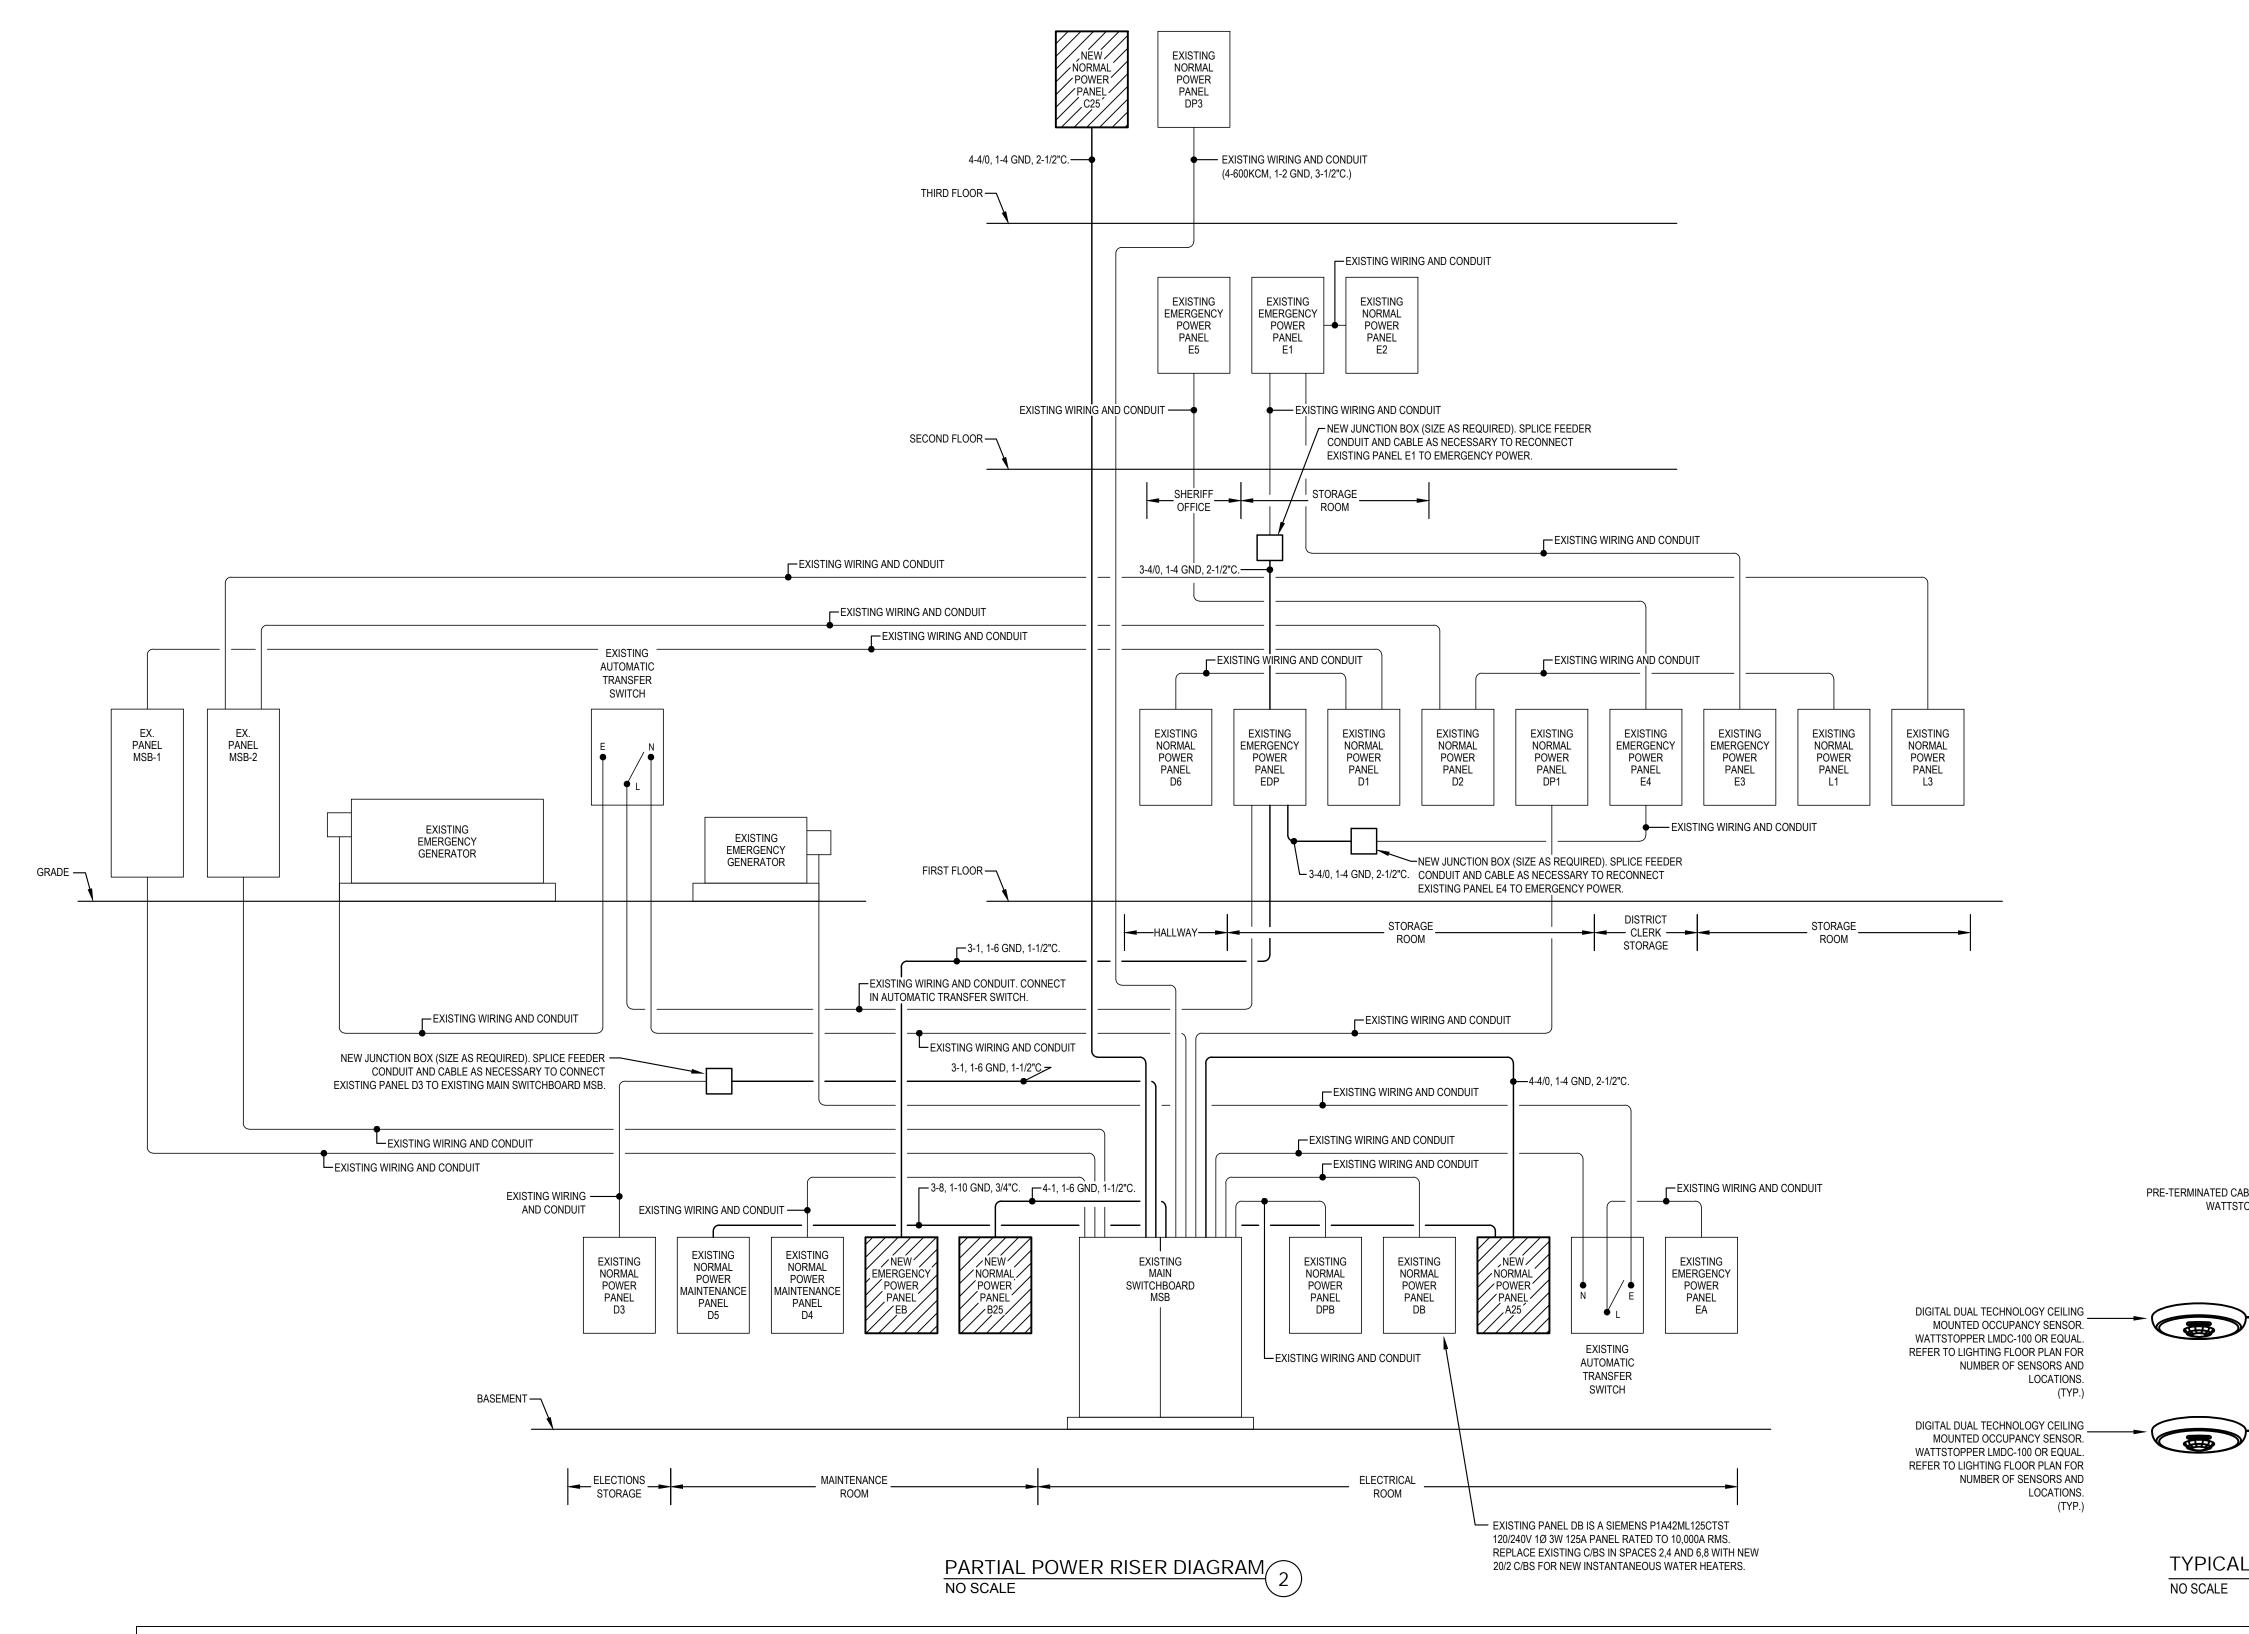
June 19, 2025

Architexas No. 2433

Date 06/19/2025

Sheet Name ENLARGED BASEMENT ELECTRICAL FLOOR PLANS





INTERIOR I	LIGHT FIXTURE SCHEDULE				
MARK	DESCRIPTION	HOUSING	BALLAST	VOLTAGE LENS/NOTES	LAMP(S)
A 1 6" ROUND 14."	7W LED RECESSED DOWNLIGHT.	7" NOMINAL HEIGHT, 6" NOMINAL DIAMETER, ALUMINUM REFLECTOR CONE, UPPER OPTICAL CHAMBER, SELF- FLANGED, UNIVERSAL MOUNTING BRACKET, INTEGRATED JUNCTION BOX, EXTRUDED HEAT SINK.	UNIVERSAL VOLTAGE (120V-277V) ELECTRONIC LED DRIVER.	120V WIDE DISTRIBUTION.	1500 LUMEN, 14.7W, 3,000K LED (PROVIDED WITH FIXTURE).
B1 4 FT. LENSED	LED STRIPLIGHT.	3" NOMINAL WIDTH, 3" NOMINAL HEIGHT, STEEL HOUSING PAINTED AFTER FABRICATION, PROVIDE WITH CHAIN HANGING SET.	UNIVERSAL VOLTAGE (120V-277V) ELECTRONIC LED DRIVER.	120V LENSED CLEAR OPTICAL SYSTEM.	1,890 LUMEN, 13W, 3,000K LED A RRAY (PROVIDED WITH FIXTURE).
B2 4 FT. LENSED	LED STRIPLIGHT.	3" NOMINAL WIDTH, 3" NOMINAL HEIGHT, STEEL HOUSING PAINTED AFTER FABRICATION, PROVIDE WITH CHAIN HANGING SET.	UNIVERSAL VOLTAGE (120V-277V) ELECTRONIC LED DRIVER.	120V LENSED CLEAR OPTICAL SYSTEM.	3,077 LUMEN, 21W, 3,000K LED ARRAY (PROVIDED WITH FIXTURE).
C1 DECORATIVE	WALL SCONCE FIXTURE	SOLID BRASS PARTS, COMPATIBLE WITH 2-1/4" FITTER SHADES, POLISHED CHROME FINISH, PROVIDE WITH A REJUVENATION 2-1/4" FITTER DOME SHADE.	120V ELECTRONIC LED DRIVER.	120V -	ONE PHILIPS 8.5A 19/LED/827 ND 120V 800 LUMEN, 8.5W, 2,700K LED LAMP
GENERAL NOTES:					
A ELECTRONIC DRIVE	ERS: HE FIXTURE DESCRIPTION FOR DRIVER VOLTAGE	-			
	TE FIXTURE DESCRIPTION FOR DRIVER VOLTAGE	<u>-</u> .			
B. FIXTURES:					
	KTURE SERIES" IS LISTED, ALL LISTED MANUFACTI RER'S PRODUCT SUBSTITUTIONS REQUIRE PRE-AF	URER'S SERIES ARE PRE-APPROVED PROVIDED THE ACTUAL PRODUCTS MEET THE DESCRIPTION. ALL OTHERS REQU	UIRE PRE-APPROVAL. WHERE ONLY ONE OR TWO SPECIFIC FIXTURES ARE L	ISTED, ALL OTHER	
2. FIXTURE CAT	ALOG NUMBERS FOR "FIXTURE SERIES" ARE NO	T COMPLETE AND ARE INTENDED ONLY TO INDICATE THE GENERAL FIXTURE SERIES TO BE PROVIDED. PROVIDE	COMPLETE CATALOG NUMBERS UPON SUBMITTAL TO MATCH ALL FIXTUR	RE REQUIREMENTS DESCRIBED.	

IGINEERS INC 3505 Olsen • Suite 110 • Amarillo, Texas 79109 Texas Registered Engineering Firm F-683

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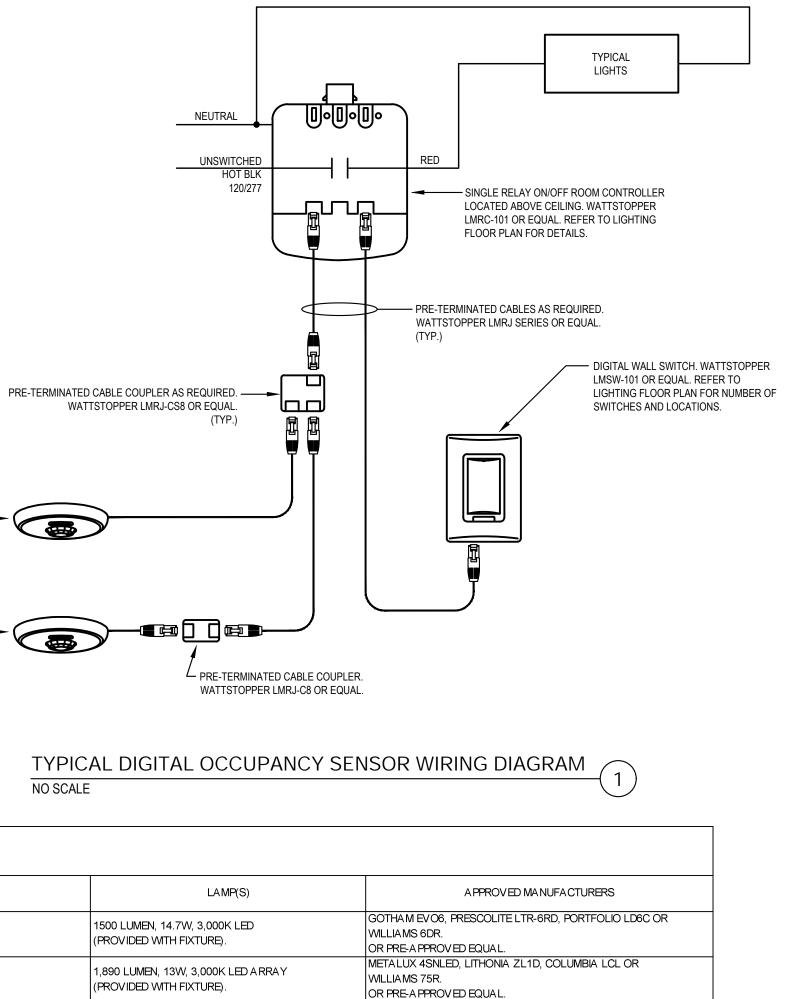


Architexas No. 2433

Date 06/19/2025

Sheet Name ELECTRICAL DETAILS

Sheet Number E801



METALUX 4SNLED, LITHONIA ZL1D, COLUMBIA LCL OR

PROVIDE WITH REJUVENATION 2-1/4" FITTER DOME SHADE

REJUVENATION ROSE CITY 2-1/4" FITTER SCONCE

WILLIAMS 75R.

OR PRE-APPROVED EQUAL.

NO SUBSTITUTIONS PERMITTED.

	Siemens SB3										
		//120V 3 phase 4									
Sections are numbered left-to-right facing switchboard front.											
	NEMA 1 encl	94. COL 198840 347									
	Service entrar										
		· · ·	rating; 100K	AIC on all bre	akers (no series ratings).						
	New C/B deno										
	Existing C/B	denoted by 'E'.									
	Section #1:	. <b>F</b>	<b>T</b> . i	T-i			<b>D</b>	Diana O			
	C/B	Frame	Trip	Trip	I access I	Phase A	Phase B	Phase C	N. Constanting		
No.	Frame	Type	Setting	<u>Type</u>	Load	Amps/Ph	Amps/Ph	Amps/Ph	<u>Notes</u>		
1	3000/3	Insulated Case	3000AT	Elec/LSI	Main Circuit Breaker	N/A	N/A	N/A			
	Castion #2.										
	Section #2: C/B	Frame	Trin	Trip		Phase A	Phase B	Phase C			
			Trip	Trip	l a a d				Mataa		
No.	Frame	Type	Setting	Type The rest Marrie	Load Panel B25	Amps/Ph	Amps/Ph	Amps/Ph	<u>Notes</u>		
1	125/3N	Molded Case	125AT	Therm-Mag		0.0	0.0	0.0			
2	-	-	-	-	Space Only	-	-	-			
3	100/2 125/2E	Molded Case	100AT 125AT	Therm-Mag	Spare	0.0	0.0	0.0			
4		Molded Case		Therm-Mag	Panel D3	0.0	0.0	0.0 14.4			
5	125/2	Molded Case	125AT	Therm-Mag	Panel DB	28.8	23.5				
6	100/2 225/3E	Molded Case	100AT 225AT	Therm-Mag	Spare Panel C25	0.0	0.0	0.0 0.0			
7	223/3E	Molded Case	225A I	Therm-Mag		0.0	0.0	0.0			
8	-	-	-	-	Space Only	-	-	-			
9	200/3 225/3E	Molded Case Molded Case	225AT 225AT	Therm-Mag	Panel D4 Panel A25	0.0	0.0	0.0 0.0			
10	400/3	Molded Case	400AT	-	Panel DPB	0.0	0.0	0.0			
11	400/3		400AT	Therm-Mag	Panel EDP	12222012		0.0			
10	400/3	Molded Case Molded Case	400AT	Therm-Mag	Panel EDP Panel DP3	0.0	0.0	0.0			
12	400/3		400AT	Therm-Mag	Panel DP3 Panel DP1	0.0	0.0	0.0			
13		Molded Case Molded Case	400AT	Therm-Mag	MSB-2	0.0		0.0			
13 14			DUUA I	Therm-Mag	MSB-2 MSB-1	0.0	0.0	0.0			
13 14 15	600/3	THE REPORT OF THE PROPERTY AND AND AND AND AND	COOAT	Thomas Man				1 11 11			
13 14		Molded Case	600AT	Therm-Mag	INI2R-1	0.0	0.0	0.0			
13 14 15	600/3	THE REPORT OF THE PROPERTY AND AND AND AND AND	600AT	Therm-Mag	Total Connect. A/PH:	28.8	23.5	14.4			

NOTE: CHANGES TO EXISTING PANELS SHOWN IN BOLD. EXISTING LOADS TO REMAIN ARE SHOWN IN REGULAR FONT.

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Date         Total         Total <th< th=""><th></th><th>Location</th><th>1st Floo</th><th>or Storage</th><th></th><th></th><th></th><th></th><th></th><th>Location</th><th>Electric</th><th>al Room</th><th></th><th>1</th><th>op fed</th><th>panelboard</th><th></th></th<>		Location	1st Floo	or Storage						Location	Electric	al Room		1	op fed	panelboard	
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2         Def of the set of the se	-				0	) 30/2E	Existing Equipment	4	5	Existing Panol D5	50/2		0	0	"	"	9
2       Defining Point E1       2222       0       0       -	5	Space Only	-	(	)				5		50/2			0	50/2	Existing A/C Unit	
0       0 <th0< th=""> <th0< th=""> <th0< th=""></th0<></th0<></th0<>	7	Existing Panel F1	225/2F	(				6	7	11.	"	-					
2         302         0					-	-	-	8	9	Spare	20/1	0	0		"		
11         Listic Support         302         0	9	n	"	(	0			- 10					0		20/1	Spare	1
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Image: Space         O         O         O         O         O         O         O         O         Space Only           31         Space         201         0         201         Space         0	7	Spare	20/1		) ^		Spare	26					0		_	Space Only	2
DB       Spare       201       0       1         11       Spare       201       0       201       Spare       0         15       Spare       201       0       201       Spare       0		Сриго	20/1			21.	Spare	28	29	Space Only	-					Space Only	3
11       Spare       201       0<	9	Spare	20/1	(	)									U	-	Space Only	
Image instance         Image instance         Image instance         Image instance           S Spare         201         0         201         Spare         31           S Spare         201         0         201         Spare         31           S Spare         201         0         201         Spare         30           S Spare         201         0         201         Spare         40           S Spare         201         0         201         Spare         50           S Spare         201         0         201         Spare         50           S Spare         201         0         201         Spare	1	Spara	20/1	(		_	Spare	30		Panel VA load/phase:							
Image: constraint of the second se		Spare	20/1		-		Spare	32		Amps/phase:		0.0	0.0	0.0			
66       Spare       201       0       201       Spare       0.0       201       Spare       90         72       Spare       201       0       201       Spare       90       Spare       90         91       Spare       201       0       201       Spare       90       Actage amps/phase:       0.0       Actade actage amps/phase:       0.0	3	Spare	20/1	(	)		-			Total VA Load		0					<u> </u>
Image: Solution of the	5	Spara	20/1	(			Spare	34									
97       Spare       201       0       201       Spare       38         98       Spare       201       0       201       Spare       38         98       Spare       201       0       201       Spare       400         11       Spare       201       0       201       Spare       400         13       Spare       201       0       201       Spare       420         13       Spare       201       0       201       Spare       420         14       Spare       201       0       201       Spare       420         15       Spare       201       0       201       Spare       420         15       Spare       201       0       201       Spare       420         15       Spare       201       0       201       Spare       420       0       301       Existing Equipment         15       Spare       201       0       201       Spare       420       0       301       Existing Equipment         15       Spare       201       0       201       Spare       420       301       Existing Equipment <tr< td=""><td></td><td>Spare</td><td>20/1</td><td></td><td></td><td>-</td><td>Spare</td><td>36</td><td></td><td></td><td>•</td><td></td><td>L I</td><td></td><td></td><td>•</td><td><b>I</b></td></tr<>		Spare	20/1			-	Spare	36			•		L I			•	<b>I</b>
99       Space       2011       0       All       Space       40         11       Space       0       2011       Space       40         13       Space       2011       0       2011       Space       42         13       Space       2011       0       2011       Space       42         14       Space       2011       0       2011       Space       42         14       Space       2011       Space       42       Space       42         15       Space       2011       Space       44       Space       44         16       2011       Space       44       Space       56       Space       10       2011       Space       10	7	Spare	20/1	(	D						1	NEW PAN	EL EB SC	HEDULE			
Image: Control of the second	0	Spara	20/1	(		_	Spare	38									
41       Spare       20/1       0       20/1       Spare       4/2         43       Spare       20/1       0       20/1       Spare       4/2         45       Spare       20/1       0       20/1       Spare       4/4         45       Spare       20/1       0       20/1       Spare       4/4         47       Spare       0       20/1       Spare       4/4         48       Spare       20/1       0       20/1       Spare       4/4         49       Spare       20/1       0       20/1       Spare       4/4         49       Spare       20/1       0       20/1       Spare       0       20/1         51       Spare       20/1       0       20/1       Spare       5/2       0       3/2       1/2       0       3/2       1/2       1/2       0       1/2       1		Spare	20/1		_	-	Spare	40								-	ar
33       Spare       201       0       Image: Constraint of the state of the stat	1	Spare	20/1	(	)									11010			
interm         O         201         Spare         44           Spare         201         0	3	Spare	20/1	(		-	Spare	42									,
Image: Space         O         20/1         Space         46           Space         20/1         0         -<		opure	20/1				Spare	44		Location			אמ		Тор		
47         Spare         201         0         c         1         A/C Unit Fist Floor Vauit         402         0         000         000           49         Spare         20/1         0         20/1         Spare         40         0         30/1         Existing Equipment           51         Spare         20/1         0         20/1         Spare         50         5         Existing Equipment         20/1         0         30/1         Existing Equipment           5         Spare         20/1         0         -         Spare         10         -         0         30/1         Existing Equipment           5         Spare         20/1         0         -         Spare         20/1         0         -         -         0         30/1         Existing Equipment           5         Spare         20/1         0         -         -         0         30/1         Existing Equipment         20/1         0         -         -         0         30/1         Existing Equipment           6         5         Spare         20/1         0         -         -         0         30/1         Existing Equipment         13         Spare <t< td=""><td>5</td><td>Spare</td><td>20/1</td><td>(</td><td>)</td><td></td><td></td><td></td><td></td><td></td><td></td><td></td><td></td><td></td><td></td><td></td><td></td></t<>	5	Spare	20/1	(	)												
a         a         0         20/1         Spare         48           9         Spare         20/1         0         -         -         0         3/1         Existing Equipment           5         Spare         20/1         0         -         -         0         0/1         Existing Equipment           55         Spare         20/1         0         -         5pare         50         -         0         -         0         -         1         0         -         5pare         20/1         0         -         5pare         0         0         20/1         Existing Equipment         20/1         0         -         1         0         -         1         0         -         1         0         -         1         0         2/1         1         0         -         1	7	Spare	20/1	(			Spare	46	1				AD LO	AD Trip	2	LOAD	NO
149         Spare         201         O         201         Spare         50           51         Spare         201/1         0         -         -         0         2011         0         -         0         3         "         "         0         0         -         0         0         -         55         Spare         201         0         -         Spare         1         0         201         Existing Equipment         201         0         -         -         0         0         301         Existing Equipment           55         Spare         201         0         -         Spare         56         Spare         201         0         -         -         0         301         Existing Equipment           57         Spare         201         0         201         Spare         56         -         -         0         301         Existing Equipment         201         0         -         -         1	,	opure	20/1			-	Spare	48		A/C Unit First Floor Va	auit 4	10/2	0	30/1	Exis	ting Equipment	2
51         Spare         20/1         0	9	Spare	20/1	(	)					3 "		"		0			
i         i	1	Spare	20/1	(		-	Spare	<mark>50</mark>						0 30/1	Exis	ting Equipment	4
33       Space Only       -       0       -       Space Only       54         55       Spare       20/1       0       -       Space Only       54         57       Spare       20/1       0       -       -       0       0.01       Existing Equipment         57       Spare       20/1       0       -       -       0       30/1       Existing Equipment         57       Spare       20/1       0       -       -       0       30/1       Existing Equipment         1       0       20/1       Spare       58       -       0       30/1       Existing Equipment         1       0       20/1       Spare       58       -       0       30/1       Existing Equipment         1       1       1       1       1       1       1       1       1       1         Amerge amps/phase:       0.0       0       -       -       0       20/1       Spare         1       Xaerage amps/phase:       0.0       -       -       0       20/1       Spare         1       Spare       20/1       0       -       -       0       20/1       Spa		Opdre	20/1				Spare	52		5 Existing Equipment	2	20/1	0	30/1	Evis	ting Equipment	6
o         o         -         Space Only         54           5         Spare         20/1         0         -	3	Space Only	-	(	)					7 Existing Equipment	2	20/1	0	0			
Image:         O         20/1         Spare         56           57         Spare         20/1         0         -         0         30/1         Existing Equipment           11         Existing Equipment         20/1         0         -         0         30/1         Existing Equipment           11         Existing Equipment         20/1         0         -         0         30/1         Existing Equipment           Amps/phase:         0.0         0         -         -         0         20/1         0         -           Amerage amps/phase:         0.0         0         -         -         0         20/1         0         -           Average amps/phase:         0.0         0         -         -         0         20/1         0         -           17         Spare         20/1         0         -         -         0         20/1         Spare           19         Spare         20/1         0         -         Space Only         -         0         -         Space Only           21         Space Only         -         0         -         Space Only         -         0         -         Space Only </td <td>5</td> <td>Spore</td> <td>20/1</td> <td>(</td> <td></td> <td>_</td> <td>Space Only</td> <td>54</td> <td></td> <td></td> <td></td> <td></td> <td></td> <td>0 30/1</td> <td>Exis</td> <td>sting Equipment</td> <td>8</td>	5	Spore	20/1	(		_	Space Only	54						0 30/1	Exis	sting Equipment	8
57         Spare         20/1         0         20/1         Spare         50           Total VA load/phase:         0         0         0         0         20/1         Spare         20/1         0         Existing Equipment           Amps/phase:         0         0         0         0         0         1         Existing Equipment         20/1         0         0         1         Spare         20/1         0         0         1         Spare         20/1         0         0         1         Spare         20/1         0         1         1         Spare         1         0         1         1         Spare         1         S	0	Spare	20/1				Spare	<mark>56</mark>		9 Existing Equipment	2	20/1	0	20/1	Evia	ting Equipment	10
Image:         Image:<	7	Spare	20/1	(	)					11 Existing Equipment	2	20/1	0		EXIS	sting Equipment	10
I otal VA load/phase:       0       0       0       20/1       Spare         Amps/phase:       0       0       0       0       0       0         Average amps/phase:       0.0       0       0       0       0       0       0         NOTE:       OHANGES TO EXISTING PANELS SHOWN IN REGULAR FONT.       0.0       0       20/1       Spare       0 <td></td> <td></td> <td></td> <td>(</td> <td></td> <td>20/1</td> <td>Spare</td> <td>58</td> <td></td> <td></td> <td></td> <td></td> <td></td> <td>0 30/1</td> <td>Exis</td> <td>ting Equipment</td> <td>12</td>				(		20/1	Spare	58						0 30/1	Exis	ting Equipment	12
Amps/phase:       0.0       0.0       0.0       0       20/1       Spare         Total VA Load:       0       0       0       0       0       0         Average amps/phase:       0.0       0       0       0       0       0         International Average amps/phase:       0.0       0       0       20/1       Spare         International Average amps/phase:       0.0       0       0       0       0       0         International Average amps/phase:       0.0       0	-	Total VA load/phase:		(						13 Spare	2	20/1	°.	00/4	0		
Total VA Load:       0       0       0       20/1       Spare         Average amps/phase:       0.0       0       20/1       0       -       -         NOTE:       CHANGES TO EXISTING PANELS SHOWN IN BOLD. EXISTING LOADS TO REMAIN ARE SHOWN IN REGULAR FONT.       19       Spare       20/1       0       -       -       0       20/1       Spare         21       Space TO EXISTING PANELS SHOWN IN REGULAR FONT.       19       Spare       20/1       0       -       -       0       20/1       Spare         21       Space Only       -       0       -       Space Only       -       0       -       Space Only         23       Space Only       -       0       -       Space Only       -       0       -       Space Only         25       Space Only       -       0       -       Space Only       -       0       -       Space Only         27       Space Only       -       0       -       <										15 Spare	2	20/1	0	20/1	Spa	re	14
Average amps/phase:       0.0       17       Spare       20/1       0       20/1       Spare         NOTE:       CHANGES TO EXISTING PANELS SHOWN IN BOLD EXISTING LOADS TO REMAIN ARE SHOWN IN REGULAR FONT.       19       Spare       20/1       0       20/1       Spare         21       Space Only       -       0       20/1       Spare       21         23       Space Only       -       0       -       Space Only         23       Space Only       -       0       -       Space Only         25       Space Only       -       0       -       Space Only         25       Space Only       -       0       -       Space Only         26       Space Only       -       0       -       Space Only         27       Space Only       -       0       -       Space Only         25       Space Only       -       0       -       Space Only         27       Space Only       -       0       -       Space Only         29       Space Only       -       0       -       Space Only         29       Space Only       -       0       -       Space Only         29 </td <td>-</td> <td>Total VA Load</td> <td></td> <td>0 20/1</td> <td>Spa</td> <td>re</td> <td>16</td>	-	Total VA Load												0 20/1	Spa	re	16
NOTE:       CHANGES TO EXISTING PANELS SHOWN IN BOLD. EXISTING LOADS TO REMAIN ARE SHOWN IN REGULAR FONT.       19       Spare       20/1       0       20/1       Spare         21       Space Only       -       0       -       Space Only         23       Space Only       -       0       -       Space Only         25       Space Only       -       0       -       Space Only         26       0       -       Space Only       -       0       -         27       Space Only       -       0       -       Space Only         27       Space Only       -       0       -       Space Only         29       Space Only       -       0       -       Space Only         29       Space Only       -       0       -       Space Only         29       Space Only       -       0       -       Space Only         19       VA load/phase:       0       0       -       Space Only	_									17 Spare	2	20/1	0				
NOTE:       CHANGES TO EXISTING PANELS SHOWN IN BOLD. EXISTING LOADS TO REMAIN ARE SHOWN IN REGULAR FONT.       20/1       Space         21       Space Only       -       0       -       Space Only         23       Space Only       -       0       -       Space Only         23       Space Only       -       0       -       Space Only         25       Space Only       -       0       -       Space Only         26       Space Only       -       0       -       Space Only         27       Space Only       -       0       -       Space Only         29       Space Only       -       0       -       Space Only										19 Spare		20/1	U	20/1	Spa	re	18
LOADS TO REMAIN ARE SHOWN IN REGULAR FONT.         21       Space Only       -       0       -       Space Only         23       Space Only       -       0       -       Space Only         23       Space Only       -       0       -       Space Only         25       Space Only       -       0       -       Space Only         26       Space Only       -       0       -       Space Only         27       Space Only       -       0       -       Space Only         27       Space Only       -       0       -       Space Only         27       Space Only       -       0       -       Space Only         29       Space Only       -       0       -       Space Only         29       Space Only       -       0       -       Space Only         -       0       -       Space Only       -       0       -         29       Space Only       -       0       -       Space Only         -       -       0       -       Space Only       -							TING							0 20/1	Spa	re	20
23Space Only-0Space Only25Space Only-0-Space Only26Space Only-0-Space Only27Space Only-0-Space Only29Space Only-0-Space Only29Space Only-0-Space Only20Total VA load/phase:00-Space Only			LUADS IU RE							21 Space Only		-					
Image: Space OnlyImage: OnlyImage: OnlyImage: OnlyImage: Only25Space Only-0-Space Only260-0-Space Only27Space Only-0-Space Only27Space Only-0-Space Only29Space Only-0-Space Only29Space Only-0-Space Only10-Space Only-029Space Only-0-Space Only29Space Only-00-29Space Only-00-29Space Only-00-29Space Only-00-29Space Only-00-200000-										23 Shace Only		_	0		Spa	ce Only	22
25Space Only-0-Space Only27Space Only-0-Space Only27Space Only-0-Space Only29Space Only-0-Space Only29Total VA load/phase:00-Space Only									H					-	Spa	ce Only	24
27       Space Only       -       0       -         29       Space Only       -       0       -         29       Total VA load/phase:       0       -       Space Only										25 Space Only		-	0				
Image: Space Only     -     0     -     Space Only       29     Space Only     -     0     -     Space Only       Image: Space Only     -     0     -     Space Only										27 Space Only			0		Spa	ce Only	26
29     Space Only     -     0     -     Space Only       0     -     Space Only     -     Space Only												-			Spa	ce Onlv	28
Total VA load/phase:   0   -   Space Only										29 Space Only			0				
													0	-	Spa	ce Only	30
										Total VA load/nhase	1		0	0			
														-			
Total VA Load: 0																	

		N	IEW PAN	EL B25 S	CHEDUL	.E				
	Typical Series:	Square	DNQ		AIC:	10 000/	A RMS Symmetrical			
	Voltage Rating:		20V 3 Phas	se 4 Wire		Copper bus, copper ground bar				
	Enclosure and mounting:		1 surface				-door construction			
	Main lug ampacity:	125A				The second s	le c/bs rated for SWD			
	Location	Mainter	nance				panelboard			
	1	C/B			PHASE C	C/B	1			
NO	LOAD	Trip	LOAD	LOAD	LOAD	Trip	LOAD	N		
1	Existing Equipment	20/1	0							
			0			20/1	Existing Equipment			
3	Existing Equipment	20/1		0						
				0		20/1	Existing Equipment			
5	Existing Equipment	20/1			0					
					0	20/1	Existing Equipment			
7	Existing Equipment	20/1	0							
0		00/4	0			20/1	Existing Equipment			
9	Existing Equipment	20/1		0		00/1				
4.4	Chara	20/4		0		20/1	Existing Equipment			
11	Spare	20/1			0	20/1	Spara	-		
13	Spare	20/1	0		0	20/1	Spare			
10	opare	20/1	0			20/1	Spare			
15	Spare	20/1		0		20/1	opare			
10		20/1		0		20/1	Spare			
17	Spare	20/1			0	20/1		_		
					0	20/1	Spare			
19	Spare	20/1	0							
			0			20/1	Spare			
21	Space Only	-		0						
				0		-	Space Only			
23	Space Only	-			0					
					0	-	Space Only	1		
25	Space Only	-	0							
			0			-	Space Only			
27	Space Only	-		0						
00				0		-	Space Only	3		
29	Space Only	-			0		Space Only			
					0	1-2	Space Only	6		
	Panel VA load/phase:	1	0	0	0	[				
	Amps/phase:		0.0					_		
	Amps/pilase.		0.0	0.0	0.0					
	Total VA Load:		0		1					
	Average amps/phase:		0.0					_		
	Average amps/phase.		0.0							
		N	IEW PAN	EL C25 S	CHEDUL	E				
	Typical Series:	Square					A RMS Symmetrical			
	Voltage Rating:		20V 3 Phas	se 4 Wire	Notes:		bus, copper ground bar			
	Enclosure and mounting:		1 surface		-		-door construction			
	Main lug ampacity: Location	225A	or Storage				le c/bs rated for SWD			
	Location		or Storage			Top led	panelboard			
		C/B	PHASE A	PHASE B	PHASE C	C/B				
NO	LOAD	Trip	LOAD	LOAD	LOAD	Trip	LOAD	1		
1	Existing Equipment	20/1	0							
			0			20/1	Existing Equipment			
3	Existing Equipment	20/1		0						
				0		20/1	Existing Equipment			
5	Existing Equipment	20/1			0					
					0	20/1	Existing Equipment			
7	Existing Equipment	20/1	0							
			0			20/1	Existing Equipment			
		20/1		0						
9	Spare	20/1		Sec.			0			
				0		20/1	Spare			
	Spare Spare	20/1		0	0					
11	Spare	20/1		0		20/1 20/1	Spare Spare			
			0		0					

20/1 Spare

20/1 Spare

0 20/1 Spare

-

0 -

0

-

-

0 - Space Only

- Space Only

Space Only

Space Only

Space Only

Space Only

15 Spare

17 Spare

19 Space Only

21 Space Only

23 Space Only

25 Space Only

Space Only

Amps/phase:

Total VA Load: Average amps/phase:

Panel VA load/phase:

29 Space Only

20/1

20/1

-

-

-

-

-

-

0

0.0

0.0

0

0.0 0.0

\_\_\_\_\_

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**REVISION HISTORY** 

1. Issued for Bid June 19, 2025

SEAL



June 19, 2025

Architexas No. 2433

Date 06/19/2025

Sheet Name PANEL SCHEDULES

